CALIFORNIA COASTAL COMMISSION

SOUTH COAST DISTRICT OFFICE 301 E. OCEAN BLVD., SUITE 300 LONG BEACH, CA 90802-4830 (562) 590-5071



Th₆a

5-23-0296 (Barney) September 7, 2023


EXHIBITS

Table of Contents

Exhibit 1 – Vicinity Map and Project Site

Exhibit 2 – Project Plans

Exhibit 3 - CoSMoS Sea Level Rise Map

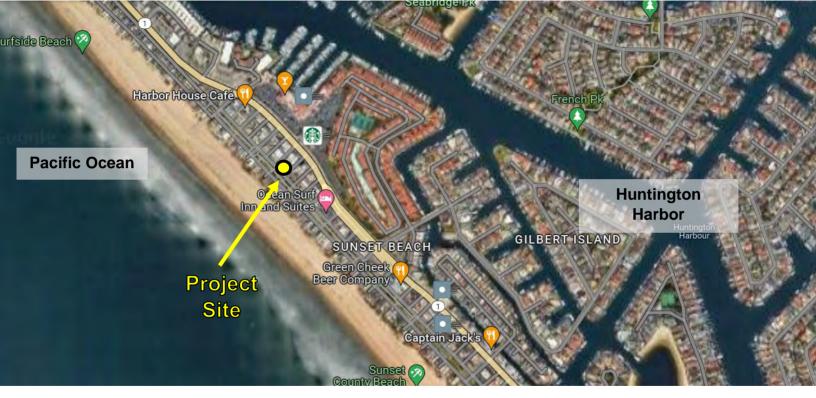

California Coastal Commission 5-23-0296 Exhibit 1 Page 1 of 2



California Coastal Commission 5-23-0296 Exhibit 1 Page 2 of 2

CALIFORNIA COASTAL COMMISSION CONDITIONS:

CALIFORNIA COASTAL COMMISSION CONDITIONS:

I. BERCH FROM DOTO REALING STORE, FROCES, GEREN WALLS, GATES, AND WINDOWS SUBJECT TO THIS FERRIT SHALL USE MITERIAS DESCRIED TO MINIMEE BRO-STRIKES WITH HE DECK PAULIN, FERRIC, GATE, OR WORDOW SUCH MITERIAS WITHOUT AND ADDRESS OF CHIEF SHALL PERFORM THE ARREST OF THE SHALL PERFORMENT OF AN EXPLORATION OF A BRO STRIKE HAVEAD, CLEAR CASES OF ELDIDIOS MAY BE RESILLED ONLY IF IT OWNINGS WIN-RECEDING DUANG THAT IS VISIBLE TO BROS RESILLED ONLY IF IT OWNINGS WIN-RECEDING DUANG THAT IS VISIBLE TO BROS WITHOUT OF A BRO STRIKE WASHING AND CHARLES OF ELDIDIOS WAY BE RESILLED ONLY IF IT OWNINGS WIN-RECEDING DUANG THAT IS VISIBLE TO BROS WITHOUT OF A BRO STRIKE WASHINGTON OF THE POWER OF A PROPOSED OF THE WASHINGTON OF THE OWNINGS WIN-RECEDING THE UP OF THE OWNINGS WIN-RECEDING THAT IS VISIBLE TO BROS WITH A BROS STRIKE AND SHALL BE THE FROM THE WASHINGTON OF THE OWNINGS WIN-RECEDING THAT IT IS VISIBLE TO BROSS WITH A BROSS WITH THE APPROVED THAT IS VISIBLE TO BROSS WITH A BROSS WITH THE APPROVED THAT IT OWNINGS WITH THE APPROVED THAT IT OWNINGS WITH THE APPROVED THAT IT IS VISIBLE TO BROSS WITH THE APPROVED THAT THE APPROV

STORAGE OF CONSTRUCTION MATERIALS, MECHANIZED EQUIPMENT AND REMOVAL OF CONSTRUCTION DEBIS. THE PERMITTEE SHALL COMPLY WITH THE FOLLOWING CONSTRUCTION—RELATED REQUIREMENTS.

D. DEMOLITION OR CONSTRUCTION DEBRIS AND SEDIMENT SHALL BE REMOVED FROM WORK AREAS EACH DAY THAT DEMOLITION OR CONSTRUCTION OCCURS TO PREVENT THE ACCUMULATION OF SEDIMENT AND OTHER DEBRIS THAT MAY BE DISCHARGED INTO COASTAL WATERS;

G. DEBRIS SHALL BE DISPOSED OF AT A LEGAL DISPOSAL SITE OR RECYCLED AT A RECYCLING FACILITY. FI THE DISPOSAL SITE IS LOCATED IN THE CONSTAL ZONE, A A RECYCLING FACILITY. FI THE DISPOSAL SITE IS LOCATED IN THE CONSTAL ZONE, A REQUIRED REFORE DISPOSAL CAN TAKE PLAZE ONLESS THE DECOUNTED DISFOSAL CAN TAKE PLAZE ONLESS THE DECOUNTED DISFOSOR DECEMBRISES THAT ON ADMINISHENT ON REMY PERMIT IS LEGALLY REQUIRED;

H. ALL STOCK PILES AND CONSTRUCTION MATERIALS SHALL BE COVERED.

ENCISSED ON ALL SIDES, SMALL BE LOCATED AS FAR AWAY AS POSSIBLE FROM
DRAIN BILETS AND ANY WATERWAY, AND SHALL NOT BE STORED IN CONTACT WITH
THE SOIL:

J. THE DISCHARGE OF ANY HAZARDOUS MATERIALS INTO ANY RECEIVING WATERS SHALL BE PROHIBITED;

SMUL BE PROMISED. AND CONTROL MANAGES SMUL BE UND BOTTO TO SUBJECT TO THE PROMISE MANAGEMENT OF THE SMUL AND CONTROL OF THE TOTAL PRODUCTS FOR ONE OF THE SMUL AND CONTROL OF

RECEIVE WATERS AND STORM DOWN INJECTS AS PUSSIBLE;

LE BEST MANDELINF PRACTICES (BMPS) AND COOL HOUSEKEEPING PRACTICES

(GHPS) DESIGNED TO PROVENT SPILLAGE AND/OR RUNOFF OF DEMOLITION OR

CONSTRUCTION—BELLED LATERNEY, AND TO CONTAIN SEQUENT OR CONTAINMENTS

ASSOCIATED WITH DEMOLITION OR CONSTRUCTION ACTIVITY, SHALL BE IMPLEMENTED

PRORE TO THE ON-SET OF SIGLAL ACTIVITY; AND

M. ALL BMPS SHALL BE MAINTAINED IN A FUNCTIONAL CONDITION THROUGHOUT THE DURATION OF CONSTRUCTION ACTIVITY.

N. DURING CONSTRUCTION OF THE PROJECT, NO RUNOFF, SITE DRAINGE OR DEWATERING SHALL BE DIRECTED FROM THE SITE INTO ANY STREET, ALLEY OR STORMDRAIN, UNLESS SPECIFICALLY AUTHORIZED BY THE CALIFORNIA REGIONAL WATER QUALITY CONTROL BOARD.

SCOPE OF WORK:

1. REMOVE ENTIRE STRUCTURE OF EXISTING TWO-STORY HOME AT EAST SIDE OF LOT.

PERFORM GROUND IMPROVEMENTS TO PORTION OF LOT UNDER PROPOSED PROJECT PER GEOTECH REPORT.

REBUILD NEW THREE-STORY STRUCTURE PER PLANS TO INCLUDE 3 BEDROOMS, 3.5 BATHS & 3 CAR GARAGES.

CONSTRUCTION STARMS AREA SHOWN ON SITE FAM IS ANNABLE FOR CONSTRUCTION ATOMIC AND STREAM CONTROLLED AND ATOMIC AND STARMS SHALL SCOUN AREA WILL BE DETERMINED BY THE GENERAL CONTRACTOR. NO STARMS SHALL COCUR ON THE BEACH, THE ROLLE TO THE BEACH, OR NOT FUBLIC PREMISES SPACE, CONSTRUCTION STARMS WAY ALSO OCCUR ON THE FINISHED FLOOR SLAB AS DETERMINED BY THE GENERAL CONTRACTOR.

5. STREET USE PERMIT — ANY REQUIRED PERMITS FOR USE OF PUBLIC STREET BY THE CITY OF HUNTINGTON BEACH BEFORE AND DURING CONSTRUCTION SHALL BE OBTAINED BY THE GENERAL CONTRACTOR.

NO WORK IS BEING PROPOSED TO THE EXISTING SECOND DWELLING (16472 24TH STREET) UNIT ON SITE.

GETTICUS:
ENVRONMENTAL CEOTECHNOLOGY LABORATORY, INC
11619 GOLDRING ROAD, SUITE A
ARCANIA, CA 91006
E26-263-3588
EMAIL: yworlegob.com
CONTACT: RYAN JONES

COASTAL HAZAROS/SEA LEVEL STUDY
GEOSOILS, INC.
5741 PALMER WAY
CARLSBAD, CA 92010
PHONE: 760-436-3155
EMAIL: dskelly@geosoilinc.com
CONTACT: DAMD SKELLY

PROJECT TEAM:

ARCHITECT:
E.C. LIND ARCHITECT, LLP
P.O. BOX 1107
CAMARILLO, CA 93011
PHONE: 805-359-6644
EMAIL: deric@selindarchite
CONTACT: ERIC LIND

CODE ANALYSIS / PROJECT DATA:

PROJECT ADDRESS: 178-514-04

LOT 2, BLOCK 124, TRACT 757

SP 17-CZ SUNSET BEACH SPECIFIC PLAN -COASTAL ZONE OVERLAY, RESIDENTIAL HIGH DENSITY DISTRICT 3,149 S.F. (0.07 ACRE) LOT AREA:

CONSTRUCTION TYPE: V-B W/ FIRE SPRINKLERS OCCUPANCY GROUP(S):

THIRD FLOOR DECK THIRD FLOOR LANDING ROOF DECK TOTAL DECK AREA

PAS:			
	EXISTING - 16472:	(NO WORK)	
	(E) FIRST FLOOR	736 S.F.	
	(E) SECOND FLOOR		
	(E) TOTAL RESIDENCE	1,557 S.F.	
	(E) SECOND FLOOR DECK	213 S.F.	
	EXISTING - 16474:	(REMOVE COMPLETELY)	
	(E) FIRST FLOOR GARAGE		
	(E) SECOND FLOOR	1.051 S.F.	
	(E) TOTAL RESIDENCE	2,142 S.F.	
	(E) SECOND FLOOR DECK	328 S.F.	
	REBUILD - 16474:		
	FIRST FLOOR	1,127 S.F	(697 S.F. GARAGE)
	SECOND FLOOR	1,338 S.F.	
	THIRD FLOOR	1.069 S.F.	
	TOTAL RESIDENCE	3 534 S F	

APPLICABLE CODES: ALL WORK SHALL CONFORM TO THE FOLLOWING CODES:

SIDE ADJACENT TO OTHER BUILDING SITES

BUILDING HEIGHT:

FRONT

REAR

PARKING:

2022 CALFORNIA BUILDING CODE
2022 CALFORNIA RESDENTIAL CODE
2022 CALFORNIA BECHANICAL CODE
2022 CALFORNIA BUILDING CODE
2022 CALFORNIA BUILDING CODE
2022 CALFORNIA BUILDING LODE
2022 CALFORNIA BUILDING STANDARDS
2022 CALFORNIA DRENCY EFFICIENCY STANDARDS
2022 CALFORNIA DRENCY EFFICIENCY STANDARDS
2022 CALFORNIA GREEN BUILDING STANDARDS

AND ALL OTHER APPLICABLE LOCAL CITY AND COUNTY CODES, ORDINANCES AND STANDARDS.

35'-0" MAXIMUM FROM CENTERLINE OF 24TH STREET

5'-0" ON GROUND FLOOR 6" ABOVE GROUND FLOOR

3'-0" ON GROUND FLOOR 5'-0" AT GARAGE 6" ABOVE GROUND FLOOR

SHEET INDEX:

ARCHITECTURAL:
A-1.1 SITE PLAN & PROJECT DATA
A-2.1 FIRST & SECOND FLOOR PLAN
A-2.2 THIRD FLOOR & ROOF PLAN
A-2.3 FOUNDATION PLAN
A-3.1 EXTERIOR ELEVATIONS
A-3.2 SECTIONS

SURVEY:

REVISIONS REVISION 1 PLANNING 1-31-2 2 CA COASTAL 6-13-2




PROJECT: REMODEL & ADDITION TO:

BARNEY RESIDENCE
16474 24TH STREET
SUNSET BEACH, CA 90742 REMODEL & ADDITION TO: DATA PROJECT

SHEET TITLE 洪 J.T.P. E.C.L 11-30-2022 C-16909 → 05/31/23

PLAN &

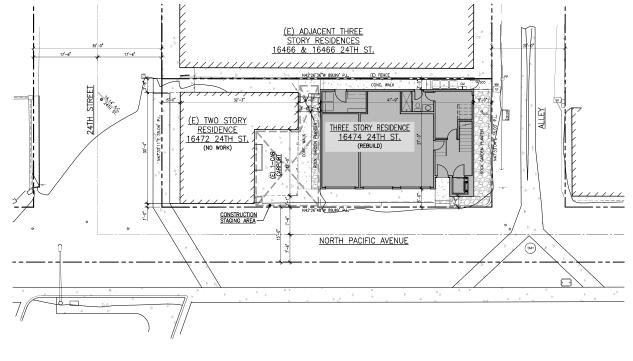



VICINITY MAP

SITE PLAN

California Coastal Commission

5-23-0296 Exhibit 2 Page 1 of 7



- APPROXIMATE LOCATION OF EXISTING WINDOWS OF ADJACENT RESIDENCE
- LINE OF (E) RESIDENCE FIRST FLOOR TO BE REMOVED
- LINE OF (E) RESIDENCE SECOND FLOOR WALLS & DECK TO BE REMOVED (E) VINYL FENCE TO REMAIN
- (N) GATE TO MATCH (E) FENCE
- STAIRS WITH 11" TREADS & ±7-1/4" RISERS (7-3/4" MAX.)
- LINE OF CEILING ABOVE
- LINE OF CELLING ABOVE PROVED PROVIDE AND RESCUE OPENING FROM ALL SLEEPING ROSES. THE NET CLOSE OPENING ARGA SHALL BE NOT LESS THAN ADDRESS OF THE NET CLOSE OPENING ARGA SHALL BE NOT LESS THAN OPENING ARGA ON THE SEST THAN ADDRESS OF THE OPENING SHALL BE NOT LESS THAN 20°, THE DETERMINE OF THE OPENING SHALL BE NOT LESS THAN 20°, THE DOTHOU OF THE CLOSE MODIFIED AND ADDRESS OF THE OPENING ARGA SHALL BE NOT LESS THAN 20°, THE DOTHOU OF THE CLOSE MODIFIED AND ADDRESS OF THE SHALL BE NOT LESS THAN 20°, THE OFFICE OF THE NOTION OF THE OPENING ARGA SHALL BE OPENING AND THE NOTION OF THE NOT
- PROVIDE METAL & CLASS GUARD RAIL WITH TOP CAP, 42" MIN. HEIGHT ABOVE DECK SURFACE, GUARDS SHALL NOT ALLOW PASSAGE OF A 4"# SPHERE, TYP.
- PROVIDE GUARD WALL WITH METAL CAP, 42" MIN. HEIGHT ABOVE DECK SURFACE.

- 2. PROVIDE WATERPROOFING MEMBRANE AT DECK SURFACE.


 13. PROVIDE WATERPROOFING MEMBRANE AT DECK SURFACE.

 13. PROVIDE CRECKET AT ECEK SURFACE TO PROVIDE DEVINAGE TO SOUPPERS.

 14. 107-12 CHAMIET FULLE W/ AC & SPINKE, AMESTOR PER PREPLACE MANAGEMENT STRUCTURE WITHIN 107. FULL MOT TO DECED WHEN MEMORY 222 & MOT TO DECED THE MEDIAN OF PROVIDED WATER STRUCKS.

 15. SCAR PANELS PER ELERCY ANALYSIS FORMS.

- APPROXIMATE LOCATION OF TRASH BINS SCREENED BY FENCE/GATE ENCLOSURE. NUMBER & SIZE OF BINS PER TRASH REMOVAL SERVICE.
- 18. ROOFTOP MECHANICAL UNITS SCREENED BY PARAPET.
- ROOF DRAINAGE SCUPPER. PROVIDE DOWNSPOUT TO DRAIN AT ROCK GARDEN PLANTER BELOW.

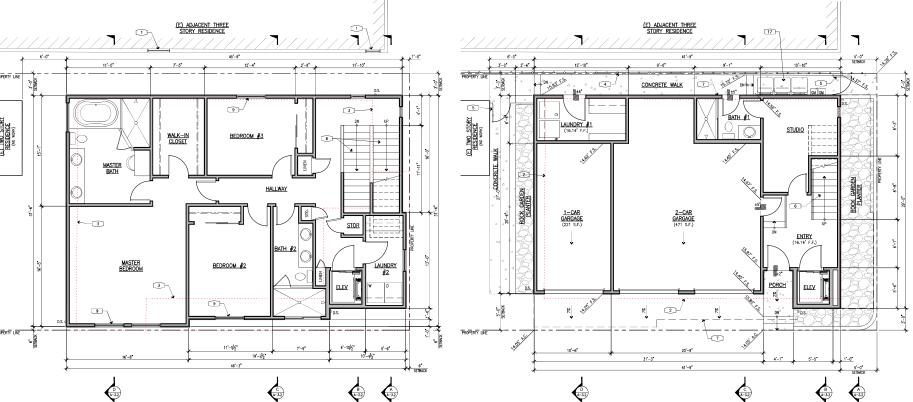

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SECOND FLOOR PLAN
SCALE: 1/4" = 1'-0"

PROJECT: REMODEL & ADDITION TO:

BARNEY RESIDENCE
16474 24TH STREET
SUNKET BEACH, CA 90742 FIRST & SECOND FLOOR PLANS SHEET TITLE :

REVISIONS

1-31-2 2 CA COASTAL 6-13-2

REVISION

E. C. LIND

P.O. BOX 1107 Camarillo, California 93011 Phone: 805-389-6644

1 PLANNING

J.T.P. E.C.L. 11-30-2022

C-16909 → 05/31/23

FIRST FLOOR PLAN
SCALE: 1/4" = 1'-0"

California Coastal Commission

5-23-0296 Exhibit 2 Page 2 of 7


GENERAL NOTES:

- ALL ROOF STRUCTURES, SUCH AS AIR CONDITIONING UNITS, ELEVATOR EQUIPMENT, OR OTHER ROOF MOUNTED APPRITEMANCES, SHALL BE SCREENED FROM WIRM AND SHALL NOT EXCEED THE OVERALL 35 FOOT HEIGHT LIMIT, EXCEPT CHANKEYS AND OTHER VENTILATION STRUCTURES NOT TO INNOVINALLY EXCEED IMPRISIONS OF TIME FEET BY TWO FEET PREY FLUE AND NOT TO EXCEED THE HEIGHT OF THE BUILDING BY MOR THAN 10 FERGE AND AND THE ALL OF THE BUILDING BY MOR THAN 10 FERGE AND THE BUILDING BY MOR THE BUILDING BY MOR THAN 10 FERGE AND THE BUILDING BY BY BUILDING BY BUILDING BY BY BY BY BUILDING BY BUILDING BY BUILDING BY BY BY BUILDING B


KEY NOTES: -

- APPROXIMATE LOCATION OF EXISTING WINDOWS OF ADJACENT RESIDENCE LINE OF (E) RESIDENCE FIRST FLOOR TO BE REMOVED
- LINE OF (E) RESIDENCE SECOND FLOOR WALLS & DECK TO BE REMOVED
- (E) VINYL FENCE TO REMAIN
- (N) GATE TO MATCH (E) FENCE STAIRS WITH 11" TREADS & ±7-1/4" RISERS (7-3/4" MAX.)
- LINE OF CEILING ABOVE
- PROVIDE METAL & GLASS GUARD RAIL WITH TOP CAP, 42" MIN. HEIGHT ABOVE DECK SURFACE, GUARDS SHALL NOT ALLOW PASSAGE OF A 4" SPHERE, TYP.
- PROVIDE GUARD WALL WITH METAL CAP, 42" MIN. HEIGHT ABOVE DECK SURFACE.

- 12. PROVIDE WATERPROOFING MEMBRANE AT DECK SURFACE.
 13. PROVIDE WATERPROOFING MEMBRANE AT DECK SURFACE.
 13. PROVIDE CROCKET AT DECK SURFACE TO PROVIDE DEVINAGE TO SOUPPERS.
 14. 107-12 CHAMBER FULLE VI, OF AS SPARK ARRESTOR PER PREPLACE MANAGEMENT STRUCTURE WITHIN 107. FULL MOT TO DECED WHEN BOOK OF 222'2 & NOT DECED THE MEDIAN OF PROVIDED WATERPOOR OF THE CONTROL OF THE CONTROL
- LOCATION OF HOT TUB SPA PER OWNER, MAXIMUM CAPACITY OF 1,000 GALLONS.
- APPROXIMATE LOCATION OF TRASH BINS SCREENED BY FENCE/GATE ENCLOSURE. NUMBER & SIZE OF BINS PER TRASH REMOVAL SERVICE.
- 18. ROOFTOP MECHANICAL UNITS SCREENED BY PARAPET.
- ROOF DRAINAGE SCUPPER. PROVIDE DOWNSPOUT TO DRAIN AT ROCK GARDEN PLANTER BELOW.

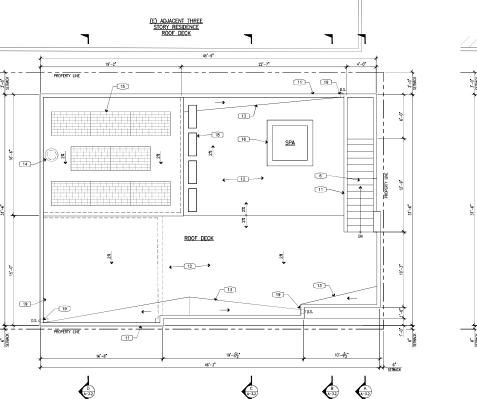

ROOF PLAN
SCALE: 1/4" = 1'-0"

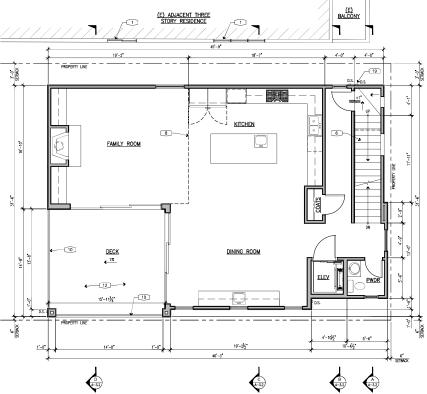

REVISIONS REVISION 1 PLANNING 1-31-2 2 CA COASTAL 6-23-2



PROJECT: REMODEL & ADDITION TO: BARNEY RESIDENCE 16474 24TH STREET SUNKET BEACH, CA 90742 ∞ THIRD FLOOR S SHEET TITLE :

> J.T.P. E.C.L.

11-30-2022

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THIRD FLOOR PLAN

California Coastal Commission

5-23-0296 Exhibit 2 Page 3 of 7

FOUNDATION NOTES:

- O SUCHMENDA SEL BIT MANUFOL.

 FOUNDATION DESIGN: PROVIDE 18" MIN. THICK CONCRETE MAT SLAB
 W/ BS BARS & 12"OL. FOUR OWER 10-MIL FOUNTHYLDER
 WHISHAME W/ ALL LAPS SEALED DO NOTI USE A SAND BASE.
 PROVIDE AN APPROVED MATERPROOF COATING TO THE EXTERIOR OF
 ALL CONCRETE FOUNDATION WASTE.

PROPOSAL FOR FLOODPROOFING:

THE HOMEONER IS PROPOSING TO FOLLOW FRAM & THE CITY OF HUNTINGTON BUCH FLAMS AND RECOMMENTATION FOR FUTURE REPORTING AND/OF WATERFROOFING AS THEY ARE DEVELOPED, WHICH MAY INCLUDE SOME OF THE OPTIONS PROPOSED IN SHEETS A2.3, A3.1, & A3.2.

REDUCING FLOOD RISK OPTIONS

NELUCING PLOUD HISK CPILINS

1. ELANG BUDDIG VITLIES

THIS MESSURE INVOLVES ELEVATIVO ALI BUILDING UTILITY SYSTEMS AND
ASSOCIATED EQUIPMENT (E.G., FURNICES, SEPTIC TANIS, AND ELECTRIC
AND GAS METERS) TO PROTECT UTILITIES FROM DAMAGE OR LOSS OF
POINCTION FROM ACCORDING MEMORIPMENS WILL ELANGE BUDDING UTILITY
POINCTION FROM ACCORDING MEMORIPMENS WILL ELANGE BUDDING UTILITY
PEDESTALS OF PLATFORMS FOR OUTDOIN EQUIPMENT, MOVING
ELANGED UTILITY ROOM, TO REDUCE FLOOD DAMAGE TO THE ORDINEST
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2. FLOOD DAMAGE-RESISTANT MATERIALS

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3. PASSIVE DRY FLOODPROOFING SYSTEM

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WITH MASSIAL PROVISE INSTALLABLE A PASSES (WORKS AUTOMATIONLY
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REVISIONS REVISION 3 CA COASTAL 7-20-2



P.O. BOX 1107 Camarillo, California 93011 Phone: 805-389-6644

PROJECT: REMODEL & ADDITION TO:

BARNEY RESIDENCE
16474 2414 STREET
SUNET BEACH, CA 90742


FOUNDATION PLAN

J.T.P. E.C.L. 11-30-2022 STAMP:

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SHEET TITLE :



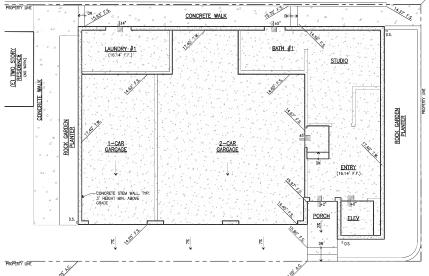


FOUNDATION PLAN
SCALE: 1/4" = 1'-0"


California Coastal Commission 5-23-0296

Exhibit 2


Page 4 of 7

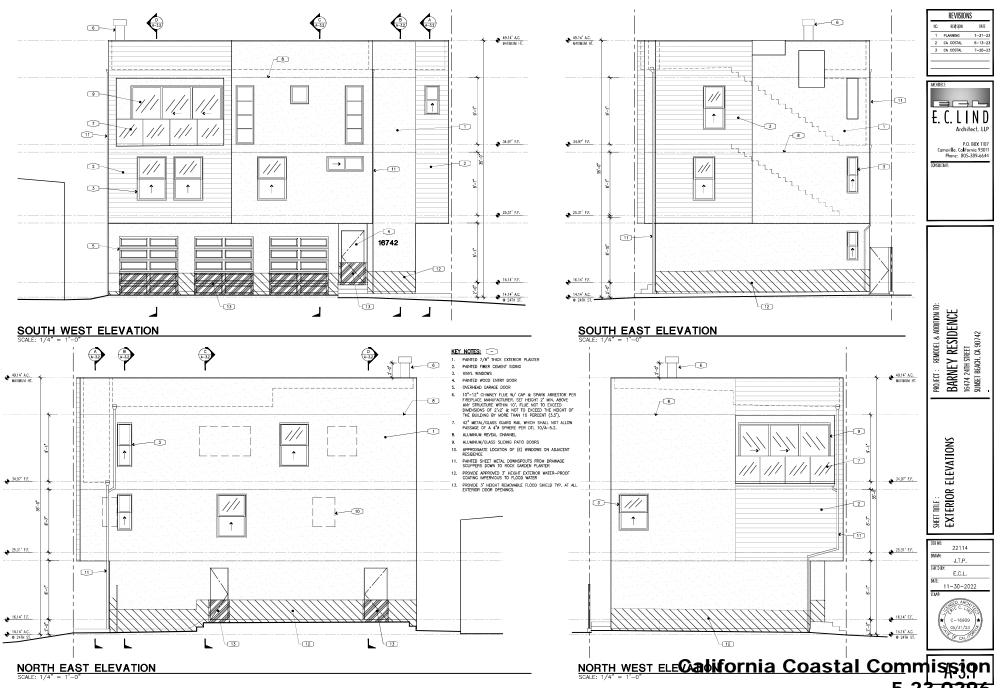


5-23-0296 Exhibit 2 Page 5 of 7 KEY NOTES: 1. CONCRETE STEM WALL, TYP. 3' HEIGHT MIN. ABOVE GRADE 3' HEIGHT FLOOD SHIELD TYP. AT ALL EXTERIOR DOOR OPENINGS ◆ 49.14" A.C. MAXIMUM HT. ⊕ 34.97° F.F. 25.31° F.F. ◆ 16.14° F.F.

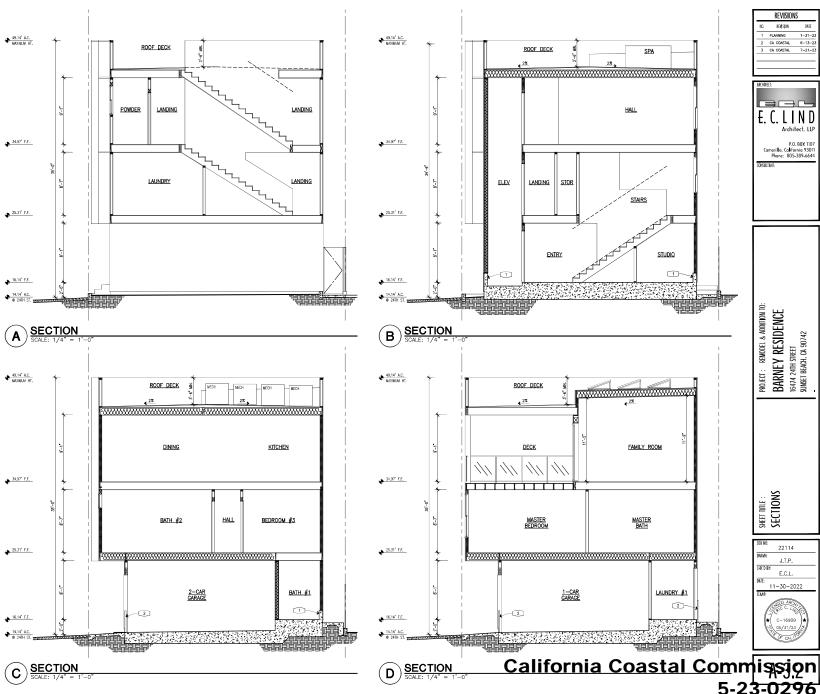

5-23-0296 Exhibit 2 Page 6 of 7

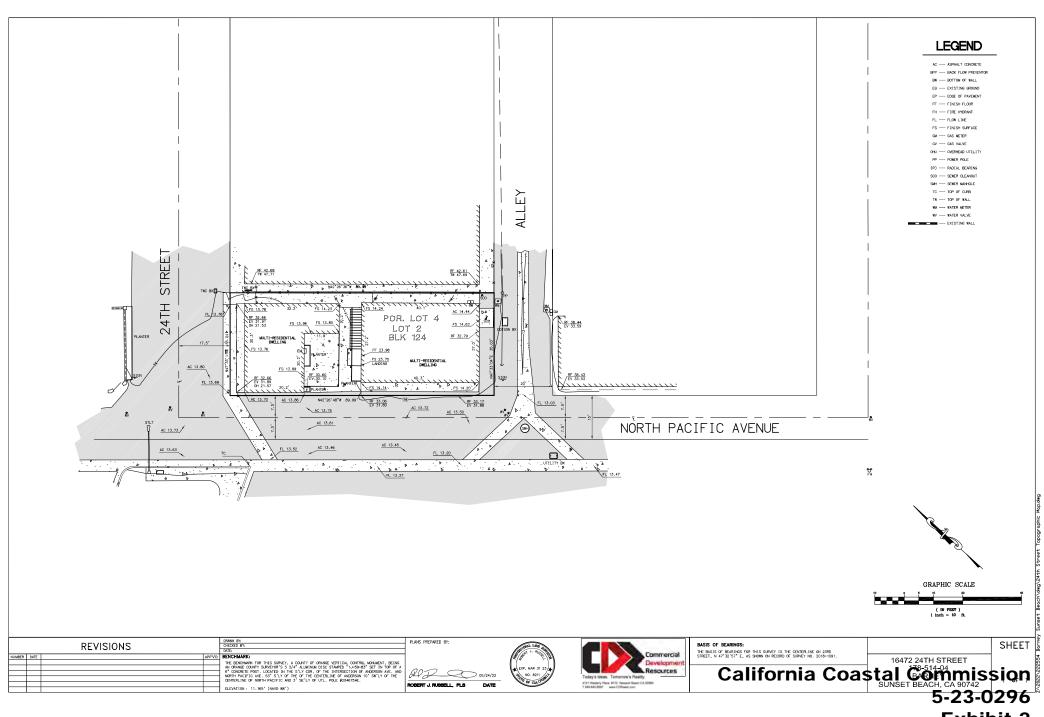

5-23-0296 Exhibit 2 Page 7 of 7

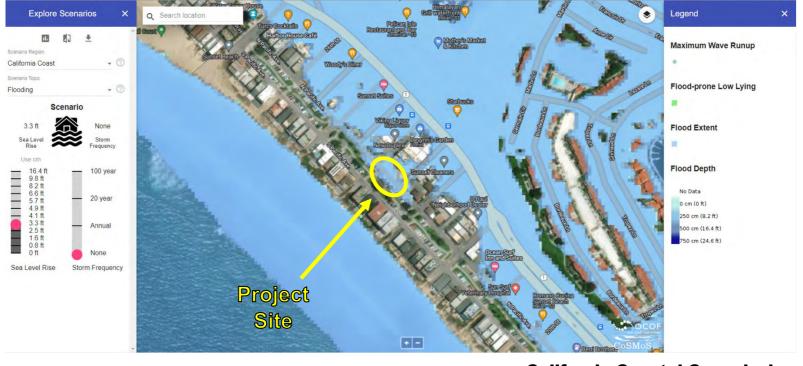

California Coastal Commission 5-23-0296 Exhibit 3 Page 1 of 2



California Coastal Commission 5-23-0296 Exhibit 3 Page 2 of 2