CALIFORNIA COASTAL COMMISSION

CENTRAL COAST DISTRICT 725 FRONT STREET, SUITE 300 SANTA CRUZ, CA 95060 PHONE: (831) 427-4863 WEB: WWW.COASTAL.CA.GOV



Th₁₆b

3-24-0149 (801 EMBARCADERO RESTAURANT/HOTEL) JUNE 13, 2024 HEARING EXHIBITS

Table of Contents

Exhibit 1: Location Map

Exhibit 2: Photos of Project Site

Exhibit 3: Proposed Project Plans

Exhibit 4: City of Morro Bay Conditional Use Permit #CUP22-09



Exhibit 1 3-24-0149 Page 1 of 1



Photo 1 shows the existing building and street end parking lot as viewed from the Embarcadero.



Photo 2 shows the rear side of the building overlooking the bay.

LIBERTINE MORRO BAY

A NEW COMMERCIAL AND HOSPITALITY BUILDING 801 EMBARCADERO, LEASE SITES 86 AND 86W MORRO BAY, CA

ARCHITECTURAL ABBREVIATIONS

ABB ANCHOR BOLT AC AIR CONDITIONING AC ASPHALT CONCRETE ADJ ADJACENT AFF ABOVE FINISH FLOOR ALUMINUM AUMINUM ABD BOARD BLDG BUILDING BLOCK	@ ∠ Ø	AT ANGLE CENTERLINE DIAMETER	FJ FO FLR FLUOR FND	FLOOR JOIST FACE OF FLOOR FLUORESCENT FOUNDATION	PR PVC PREFAB R	PAIR POLYVINYL CHLORIDE PREFABRICATED RADIUS/RISER
ALUM ALUMINUM ALUMINUM GD GD GABABAGE DISPOSAL RO ROUGH OPENI BD BOARD BLK BLOCK GS GALVANIZED STEEL RWD REDWOOD BLK BLOCKING BLOCKING BM BEAM BO BOTTOM OF BOTTOM OF FRAMING BO BOTTOM OF FRAMING BO BOTTOM OF FRAMING BO BOTTOM OF BEAM BO BO BOTTOM OF	A/C AC AD.	AIR CONDITIONING ASPHALT CONCRETE ADJACENT	FTG FHWS FURR	FOOTING FLATHEAD WOOD SCREW	RDWD REFR REINF	REDWOOD REFRIGERATOR REINFORCEMENT
BUD BURDING BLK BLOCK BLK BLOCK BLK BLOCKING BM BEAM BO BOTTOM OF BO BOTTOM OF FRAMING BO BOTTOM OF FRAMING BO BOTTOM OF FRAMING BO BOTTOM OF BEAM BOTTOM OF BEAM BOTTOM OF BEAM BOTTOM OF BEAM BO BOTTOM OF BEAM BOTTOM OF			GA GD	GARBAGE DISPOSAL	RM RO	ROOM ROUGH OPENING
BLKG BM BEAM BO BOTTOM OF BOF BOTTOM OF FRAMING BO BOTTOM OF FRAMING BO BOTTOM OF FRAMING BO BOTTOM OF BEAM BOTTOM OF BEAM BO BOTTOM OF BEAM BOTTOM OF BEAM BO BOTTOM OF BEAM BO BOTTOM OF BEAM BOTTOM OF BEAM BO BO BOTTOM OF BEAM BO BO BO BOTTOM OF BEAM BO BO BOTTOM OF BEAM BO BO BO BO BO BO BOTTOM OF BEAM BO	BLD	G BUILDING	GS GYP	GALVANIZED STEEL GYPSUM	RWD	REDWOOD
BOF BOTTOM OF FRAMING BO BOTTOM OF BEAM HTR BOBBM BOTTOM OF BEAM HYAC CASE CATCH BASIN C.J. CONTROL JOINT IN INCH. INTERIOR SH. SHOWER SHOWER SHOWER SH. SHOWER SHOWER SH. SHOWER SHO	BLK BM	G BLOCKING BEAM	HB	HOSE BIBB	SHLF SHLV	SHELF SHELVING
CAB CABINET CB CATCH BASIN CJ CONTROL JOINT CLG CEILING CLR CLEAR CMU CONCRETE MASONRY UNIT CO CLEANOUT COL COLUMN CONCRETE SHINGLES CONC CONCRETE CONT CONTINUOUS CSK COUNTER SINK CSMT CASEMENT CASEMENT MB MACHINE BOLT CT CERAMIC TILE CT CENTER CONC COLD WATER MECH MECHANICAL DIAM DOWN MIN MINIMUM DOWN NAT MATURAL DIAM DOWN NAT MATURAL DIAM DIMENSION DN DOWN NAT NATURAL DIM DIMENSION DN DOWN NAT NATURAL DN DOWN NOT IN CONTRACT UNO UNLESS NOTEI OPPENSE EA EACH EJ EXPANSION JOINT ELEC ELECTRICAL OC ON CENTER WO WITHOUT ELEC ELECTRICAL OC ON CENTER WO WITHOUT ELEC ENCL EUCLOSURE OO DUTSIBE DIAMETER WO WITHOUT WATER PEACH EXTERIOR OPPENING WW WATER RESIST FINISH FLOOR PEMB PREFERORATE WW WHEDED WIRE PEMP PERFORATE WWW WELDED WIRE	BOI BO	BOTTOM OF FRAMING BOTTOM OF	HTR	HEATER HEATING/VENTILATING/	S&P SEL SH	SHELF AND POLE SELECT SINGLE HUNG
CLG CEILING CLR CLEAR CMU CONCRETE MASONRY UNIT CO CLEANOUT COL COLUMN COMPOSITE SHINGLES CONC CONSTRUCTION CONT CONSTRUCTION CONT CONSTRUCTION CSK COUNTER SINK CSK COUNTER SINK CTT CERAMIC TILE CT CENTER CT COUNTER SINK CT COUNTER SINK CT COUNTER SINK CT CENTER CT CENTER CT CENTER CT CENTER CT CENTER MED MEDIUM MINIMUM MEDIUM TOM TOP OF PARAMIN MINIMUM MEDIUM TOM TOP OF PARAMIN MINIMUM MEDIUM TOM TOP OF PARAMIN MINIMUM MINIMUM TOPL TOP OF PARAMIN MINIMUM MINIMUM TOPL TOP OF PARAMIN TOPL TOP OF PA	СВ	CATCH BASIN		HOT WATER	SHTG	SHEATHING
COL CLEANOUT COL COLUMN COMP COMPOSITE SHINGLES CONC CONCRETE CONST CONSTRUCTION CONT CONTINUOUS CSK COUNTER SINK CSK COUNTER SINK CSK COUNTER SINK CSK COUNTERSINK CTT CERAMIC TILE MB MACHINE BOLT CT CERAMIC TILE MC MEDICINE CABINET CT CENTER MED MEDIUM TOM TOP OF MASON MIN MINIMUM TOP OF MASON MIN MINIMUM TOP OF PARAF CW COLD WATER MFG MANUFACTURER DIA DIAMETER DIA DIAMETER DIA DIAMETER DIA DIAGONAL DIM DIMENSION DN DOWN NAT NATURAL DIM DIMENSION NAT NATURAL DIM DIMENSION NAT NATURAL DIM DIMENSION NAT NATURAL DIM DISHWASHER NO NUMBER NO NUMBER NO NUMBER NO NUMBER NO NUMBER NO NUMBER WW WITH ELEC ELECTRICAL OC ON CENTER W/W WITH ELEC ENCL SURSTING EW EACH WAY OFCI OWNER FURNISHED, WD WOOD FALTE CONTRACTOR W/W WITH WITH WATER HEATE W/W WITH WATER HEATE W/W WATER REATE W/W WATER REASE FINISH FLOOR FG FIXED GLASS FINIS FLATHEAD WAY WELDED WIRE W/W WELDED WIRE	CLC CLF	G CEILING R CLEAR J CONCRETE MASONR'	INT INSUL	INTERIOR	SKL SL	SKYLIGHT SLIDER (WINDOW)
COLUMN COMPOSITE SHINGLES CONC CONCRETE CONC CONCRETE CONST CONSTRUCTION MATL MATERIAL T TREAD CONT CONTINUOUS CSK COUNTER SINK MAX MAXIMUM T&B TOP & BOTTOM CSK COUNTER SINK MAX MAXIMUM T&G TONGUE AND CONTOWN TOR TONGUE AND CONTOWN TO TOP OF A BOTTOM CT CERAMIC TILE MC MECHANICAL TO TOP OF BEAM CTR CENTER MED MEDIUM TOM TOP OF PARAF CW COLD WATER MED MEDIUM TOM TOP OF PARAF DS DOWNSPOUT MIN MINIMUM TOPL TOP OF PARAF DIA DIAMETER MTL METAL THK THICK DIA DIAMETER MTL METAL THY TELEVISION DN DOWN NAT NATURAL TYP TYPICAL DIM DIMENSION NAT NATURAL DN DOWN NIC NOT IN CONTRACT DW DISHWASHER NTS NOT TO SCALE EA EACH EJ EXPANSION JOINT ELEC ELECTRICAL ENCL ENCLOSURE EQ EQUAL ENCL ENCLOSURE CON CENTER OP OPENING EXTENDED WIN WINDOW FF FINISH FLOOR FG FIXED GLASS FHMS FLATHEAD MACHINE FOR DOPENING FAU FORCED AIR UNIT FF FINISH FLOOR FG FIXED GLASS FHMS FLATHEAD MACHINE SCREW LAWATORY LAVATORY STRUCT STRUCTURAL AVATORY STRUCTURAL AVATORY STRUCT STRUCTURAL T TREAD TOP & BOTTOM T&B TOP OF BEOTTOM TO TOP OF BEOTTOM TO TOP OF BEOTTOM TO TOP OF BEOTTOM TO TOP OF BEAM MAX MAXIMUM TOM TOP OF PEASE TO TOP OF BEOTTOM TO TOP OF PEASE TO TOP OF BEOTTOM TO TOP OF PLATE TO TOP OF BEOTTOM TO TOP OF BEOTTOM TO TOP OF PLATE TO TOP OF BEOTTOM TO TOP OF BEOTTOM TO TOP OF BEOTTOM TO TOP OF PLATE TO TOP OF BEOTTOM TO TOP OF BEOTTOM TO TOP OF PLATE		CLEANOUT	JST	JOIST	SQ	SQUARE
CONST CONSTRUCTION CONT CONTINUOUS CSK COUNTER SINK CSMT CASEMENT CT CERAMIC TILE CT CENTER CW COLD WATER DS DOWNSPOUT DBL DOUBLE DIA DIAMETER DIA DIAMETER DIA DIAMETER DIA DIAMETER DIA DIAMETER DIA DOWN DISHWASHER DIA DOOR DW DISHWASHER DW DISHWASHER CY COLD WATER CY COLD WATER DIA DOOR DOWN DOWN DOWN DOWN DOWN DOWN DOWN DOWN	COI	MP COMPOSITE SHINGLE			STOR	STORAGE
CSMT CASEMENT CASEMENT CT CERAMIC TILE CTSK COUNTERSINK MC MEDICINE CABINET CT CERAMIC TILE MC MEDICINE CABINET CTR CENTER MECH MECHANICAL TOB TOP OF BEAM MECH MECHANICAL TOB TOP OF BEAM MECH MECHANICAL TOB TOP OF MASON MFG MANUFACTURER TOP TOP OF PARAF MIN MINIMUM TOPL TOP OF PARAF TOP OF MASON TOP OF MASON TOP OF MASON TOP OF PARAF MIN MINIMUM TOPL TOP OF PARAF TOP OF MASON TOP OF PARAF TOP OF MASON TOP OF MASO	COI	NST CONSTRUCTION NT CONTINUOUS	MATL	MATERIAL		
CTSK COUNTERSINK CTR CENTER CW COLD WATER MECHANICAL MECHANICAL MECHANICAL MECHANICAL TOB TOP OF BEAM TOP OF MASON TOP OF MASON TOP OF MASON TOP OF PARAF TOP TOP OF PARAF TOP TOP OF PARAF TOP TOP OF PARAF TOP TOP OF MASON TOP OF BEAM TOP OF MASON TOP OF PARAF TOP TOP OF MASON TOP OF MASON TOP OF BEAM TOP OF MASON TOP OF M	CSI	MT CASEMENT			T&G TC	TONGUE AND GROOVE TRASH COMPACTOR
DS DOWNSPOUT MISC MISCELLANEOUS TOS TOP OF SHEAT THE THICK T	CTS CTF	SK COUNTERSINK R CENTER	MECH MED	MECHANICAL MEDIUM	TOB TOM TOP	TOP OF BEAM TOP OF MASONRY TOP OF PARAPET
DIAG DIAGONAL DIM DIMENSION DN DOWN DN DOWN DR DOOR DISHWASHER DW DISHWASHER EA EACH EJ EXPANSION JOINT ELEC ELECTRICAL ENCL ENCLOSURE EQ EQUAL EW EACH WAY (E) EXISTING EXT EXTERIOR FAU FORCED AIR UNIT FF FINISH FLOOR FG FIXED GLASS FHMS FLATHEAD MACHINE PERF PERFORATE DIM NAT NATURAL NO NORTH TV TELEVISION TYP TYPICAL TOWN TYP TYP TYPICAL TOWN TYP TYPICAL TOWN TYP TYP TYP TYPICAL TOWN TYP	DBL	DOUBLE	MISC	MISCELLANEOUS	TOS THK	TOP OF SHEATHING THICK
DR DOOR NO NUMBER UNO UNLESS NOTED OTHERWISE EA EACH OF OVER EJ EXPANSION JOINT OBS OBSCURE ENCL ENCLOSURE OD OUTSIDE DIAMETER WC WATER CLOSE EW EACH WAY OFCI OWNER FURNISHED, WD WOOD (E) EXISTING EXTERIOR OH OVERHEAD OPG OPENING FAU FORCED AIR UNIT OS OVERFLOW SCUPPER WIN WINDOW FF FINISH FLOOR FG FIXED GLASS FHMS FLATHEAD MACHINE PERF PERFORATE SCREW WMM WELDED WIRE	DIM	DIMENSION	NAT	NATURAL	TV	TELEVISION
EJ EXPANSION JOINT ELEC ELECTRICAL OC ON CENTER W/O WITHOUT ENCL ENCLOSURE OD OUTSIDE DIAMETER EW EACH WAY (E) EXISTING EXT EXTERIOR OPG OPENING FAU FORCED AIR UNIT FF FINISH FLOOR FG FIXED GLASS FHMS FLATHEAD MACHINE SCREW ODS OBSCURE W/O WITHOUT OC ON CENTER OC ON CENTER OC ON CENTER W/O WITHOUT OC ON CENTER OC O	DR	DOOR	NO	NUMBER	UNO	UNLESS NOTED OTHERWISE
ELEC ELECTRICAL ENCL ENCLOSURE EQ EQUAL EW EACH WAY (E) EXISTING EXT EXTERIOR FAU FORCED AIR UNIT FF FINISH FLOOR FG FIXED GLASS FHMS FLATHEAD MACHINE SCREW ENCL ENCLOSURE OC ON CENTER W// WITH W/O WITHOUT OD OUTSIDE DIAMETER WC WATER CLOSE OWNER FURNISHED, WD WOOD CONTRACTOR WH WATER HEATE WIN WROUGHT IRO OPG OPENING WIN WINDOW WP WATERPROOF WP WATERPROOF WR WATER RESIST WETAL BUILDING WWF WELDED WIRE WWM WELDED WIRE					VIF	VERIFY IN FIELD
FAU FORCED AIR UNIT OS OVERFLOW SCUPPER WIN WINDOW FF FINISH FLOOR PEMB PRE-ENGINEERED WR WATER RESIST FHMS FLATHEAD MACHINE PERF PERFORATE WWM WELDED WIRE SCREW PL PROPERTY LINE	ELE EN EQ EW	C ELECTRICAL CL ENCLOSURE EQUAL EACH WAY	OC OD	ON CENTER OUTSIDE DIAMETER OWNER FURNISHED, CONTRACTOR	W/O WC WD WH	WITHOUT WATER CLOSET
FF FINISH FLOOR PEMB PRE-ENGINEERED WR WATERPROOF FG FIXED GLASS METAL BUILDING WWF WELDED WIRE FHMS FLATHEAD MACHINE PERF PERFORATE WWM WELDED WIRE SCREW PL PROPERTY LINE WWM WELDED WIRE			OPG	OPENING		WROUGHT IRON WINDOW
SOILW PL PROPERTY LINE	_ ^ ·	FINISH FLOOR		PRE-ENGINEERED	WP WR	WATERPROOF WATER RESISTANT
	FF FG	AS FLATHEAD MACHINE		PERFORATE		WELDED WIRE MESH

TRUE NORTH

ROOM NUMBER

150 SF ROOM AREA

1'-0" ← CEILING HEIGHT

FIN CEILING FINISH

CEILING MATERIAL

(E) CONSTRUCTION

TO BE REMOVED

CONSTRUCTION

CONSTRUCTION

PROPERTY LINE

EASEMENT

PROPERTY SETBACK /

—— (E) TO REMAIN

— LINE BELOW

---- LINE ABOVE

PROJECT DESCRIPTION

SCOPE OF THIS PROJECT INCLUDES THE FOLLOWING

THIS PROJECT WILL DEMOLISH THE MAJORITY OF AN EXISTING 4677 SF TWO STORY BUILDING WITH BASEMENT AND RECONSTRUCT INTO A 5206 SF MIXED-USE BUILDING (529 ADDITIONAL SF) FEATURING AN UPDATED RESTAURANT WITH INDOOR/OUTDOOR DINING, UPGRADED BASEMENT AREA, NEW COFFEE SHOP, NEW 7 UNIT HOTEL, NEW SECOND LEVEL VIEWING DECK, NEW PUBLIC DOCK, AND SIGNIFICANT SITE IMPROVEMENTS.

THE UPDATED RESTAURANT WILL INCLUDE OUTDOOR DINING AT THE EAST/WEST SIDES, AREAS FOR LIVE MUSIC, COVERED OUTDOOR DINING, ADA IMPROVEMENTS, KITCHEN/BAR UPGRADES AND A CONFERENCE/EVENT SPACE. THE SECOND LEVEL 7 UNIT HOTEL/VACATION RENTAL WILL HAVE PRIVATE PATIOS WITH ACCESS FROM THE SECOND LEVEL VIEWING DECK.

SITE IMPROVEMENTS INCLUDE A NEW 15 FOOT HARBORWALK ACCESS IMPROVEMENTS WITH NEW PILINGS, CONTINUOUS COASTAL ACCESS FROM BOTH NORTH AND SOUTH ENDS, LOWER DOCK AREA WITH RAMP, EMBARCADERO PUBLIC IMPROVEMENTS BOTH ON THE LEASE SITE AND ADJACENT CITY PARCEL, NEW PASSENGER LOADING AND DROP OFF ZONE, AND PLAZA

THE PROJECT AS CONFIGURED EXCEEDS THE SETBACK REQUIREMENT AT SECOND FLOOR ALONG THE EMBARCADERO STREET FRONTAGE, EXCEEDS THE 17 FOOT HEIGHT, AND THE VIEW CORRIDOR 45 DEG ANGLE AT THE SW BUILDING CORNER. HOWEVER, SIGNIFICANT PUBLIC BENEFIT HAS BEEN PROVIDED TO MITIGATE FOR THESE MODIFICATIONS THAT ARE REQUESTED.

GENERAL NOTES

ALL WORK SHALL CONFORM TO: (A) THE MINIMUM STANDARDS OF THE LATEST EDITION OF THE INTERNATIONAL BUILDING CODE AND ALL RELATED DOCUMENTS PUBLISHED BY THE I.C.C. WHICH HAVE BEEN ADOPTED BY THE LOCAL GOVERNING AGENCY; (B) ALL REGULATIONS AND ORDINANCES OF ALL LOCAL GOVERNING AGENCIES; (C) ANY SPECIAL CONDITIONS REQUIRED BY THE LOCAL GOVERNING AGENCIES; AND (D) ALL CALIFORNIA STATE CODE AMENDMENTS (BUILDING STANDARDS CODE) TITLE 24

ALL CODES REFERENCED SHALL BE CALIFORNIA EDITIONS. THE CODES REFERENCED IN THESE PLANS ARE AS FOLLOWS:

- 2022 CALIFORNIA RESIDENTIAL CODE (CRC)
- 2022 CALIFORNIA MECHANICAL CODE (CMC) 2022 CALIFORNIA PLUMBING CODE (CPC)
- 2022 CALIFORNIA FIRE CODE (CFC) 2022 CALIFORNIA ELECTRICAL CODE (CEC)
- 2022 CALIFORNIA GREEN CODE (CGC) CALIFORNIA STATE ENERGY CONSERVATION STDS. (TITLE 24)
- ALL WORK DESCRIBED IN THE DRAWINGS SHALL BE VERIFIED BY THE CONTRACTOR FOR DIMENSION, GRADE, EXTENT AND COMPATIBILITY TO THE EXISTING SITE. ANY DISCREPANCIES AND UNEXPECTED CONDITIONS THAT AFFECT OR CHANGE THE WORK DESCRIBED IN THE CONTRACT DOCUMENTS SHALL BE BROUGHT TO THE ARCHITECT'S ATTENTION IMMEDIATELY. DO NOT PROCEED WITH THE WORK IN THE AREA OF DISCREPANCIES UNTIL ALL SUCH DISCREPANCIES ARE RESOLVED. IF THE
- CONTRACTOR CHOOSES TO DO SO, HE SHALL BE PROCEED AT HIS OWN RISK. OMISSIONS FROM THE DRAWINGS AND SPECIFICATION OR THE MISDESCRIPTION OF THE WORK WHICH IS MANIFESTLY NECESSARY TO CARRY OUT THE INTENT OF THE DRAWINGS AND SPECIFICATIONS, OR WHICH IS CUSTOMARILY PERFORMED, SHALL NOT RELIEVE THE CONTRACTOR FROM PERFORMING SUCH OMITTED OR MISDESCRIBED DETAILS OF THE WORK AS IF FULLY AND COMPLETELY SET FORTH

AND DESCRIBED IN THE DRAWINGS AND SPECIFICATIONS.

- DIMENSIONS SHOWN SHALL TAKE PRECEDENCE OVER DRAWING'S SCALE OR PROPORTION. LARGER SCALE DRAWINGS SHALL TAKE PRECEDENCE OVER SMALLER
- THE CONTRACTOR SHALL FOLLOW ALL APPLICABLE INDUSTRIAL SAFETY REGULATIONS. THE LOCAL GOVERNING AGENCY, THE ARCHITECT, AND THE OWNER SHALL NOT BE RESPONSIBLE FOR ENFORCING SAFETY REGULATIONS.
- THE ARCHITECT OF RECORD SHALL BE RESPONSIBLE FOR REVIEWING AND COORDINATING ALL SUBMITTAL DOCUMENTS PREPARED BY OTHERS, INCLUDING DEFERRED SUBMITTAL ITEMS, FOR COMPATIBILITY WITH THE DESIGN OF THE BUILDING. 2022 CBC APPENDIX CHAPTER 107.3.4
- NO HAZARDOUS MATERIALS SHALL BE STORED AND / OR USED WITHIN THE BUILDING, WHICH EXCEED THE QUANTITIES LISTED IN CHAPTER 27 OF THE 2022 CFC
- CONTRACTOR TO NOTIFY OWNER PRIOR TO COMMENCING WITH ANY WORK. CONTRACTOR SHALL CONFORM TO ANY REQUIREMENTS FOR NOISE AND DUST CONTROL TRASH, STORAGE, WORK HOURS, SITE ACCESS, SIGNAGE, ETC. AS
- CONTRACTOR IS RESPONSIBLE FOR SCHEDULING INSPECTIONS BY THE BUILDING DEPT. AND OTHER AGENCIES AS REQUIRED.
- PRIOR TO ISSUANCE OF THE BUILDING PERMIT, THE GENERAL CONTRACTOR SHALL SUBMIT A SOLID WASTE RECYCLING PROGRAM TO THE BUILDING DEPARTMENT FOR REVIEW AND APPROVAL. THE PROGRAM SHALL ADDRESS AND INCLUDE, BUT IS NOT NECESSARILY LIMITED TO: CONCRETE WASTE, GYPSUM BOARD, WOOD, METAL AND EXCESS EXCAVATION MATERIALS.
- THE APPROVED PROJECT ALLOWED TO BE CONSTRUCTED BY THE BUILDING PERMIT SHALL CONFORM TO THE FIRE SAFETY PLAN REQMTS. AS DEEMED NECESSARY BY THE FIRE DEPT HAVING JURISDICTION FOR THE BLDG PERMIT. PRIOR TO BEGINNING CONSTRUCTION THE PROPERTY OWNER SHALL READ THE FIRE SAFETY PLAN ISSUED BY THE FIRE DEPT AND BECOME FULLY AWARE OF ALL NECESSARY FIRE PROTECTION REQMTS AS MANY OF THESE FIRE PROTECTION REQMTS MAY REQUIRE THE INSTALLATION OF FIRE SPRINKLERS / SPECIAL SAFETY GLAZED WINDOWS / SPECIAL DRIVEWAY-ROADWAY REQMTS AND OTHER SPECIAL



CODE ANALYSIS

APN	066-322-008
LEGAL DESCRIPTION	CY MB PM 3/10 PAR 20 (LS 86)
LOCAL JURISDICTION	MORRO BAY, SLO COUNTY
LOCAL CODE	MORRO BAY MUNICIPAL CODE, TITLE 17
LOCAL ZONING	WF/PD/S.4 WATER FRONT, PLANNED DEVELOPMENT, DESIGN CRITERIA
FIRE ZONE	N/A
FLOOD ZONE	ZONE AE
COASTAL ZONE	Y

		EXISTING	PROPOSED	
LOT COVERAGE CALCS				
LAND PORTION OF PARCEL		5,430 SF	5,430 SF	
1ST FLOOR BUILDING AREA OVER LAND PORTION		3,304 SF	4,100 SF	
1ST FLOOR COVERAGE (ALLOWED 70%)		(3,304/5,430) = 60.8%	(3,800 / 5,430) = 70%	
ALLOWED FIRST FLOOR COVERAGE (ALLOWED 70%)		3,800 SF	3,800 SF	
2ND FLOOR AREA OVER LAND PORTION		2,777 SF	2,433 SF	
2ND FLOOR COVERAGE 70% OF ALLOWED 1ST FLOOR BUILDING COV	(2,777 / 3,800) = 73.1%	(2,433 / 3,800) = 64%		
WATER PORTION OF PARCEL		1,957 SF	1,957 SF	
SQUARE FOOTAGE OF BUILDING OVER WATER (1ST FLOOR)	1,047 SF	1,047 SF		
SQUARE FOOTAGE OF BUILDING OVER WATER (2ND FLOOR)	1,047 SF	544 SF		
FLOOR AREA RATIO (FAR) CALCS				
LAND PORTION OF PARCEL	5,430 SF	:	5,430	
1ST FLOOR BUILDING AREA OVER LAND PORTION	3,304 SF	=	4,100 SF	
2ND FLOOR BUILDING AREA	1 2 1 1 1 SE			

1.14

87 SF

POTTED PLANTS AT 2ND FLOOR 205 SF TOTAL 172 SF ROOF SLOPES "FLAT" AREA 383 SF 3026 / 3409 = 4:12 MIN. AREA 3026 SF TOTAL 3409 SF 88% SLOPED EXISTING | ALLOWED | ACTUAL | ACTUAL | 1ST FLR | 2ND FL SETBACKS 5'-0" AVG | 5'-4" | 5'-4" FRONT [STREET] ~2'-0" REAR [WATER] 10'-0" 15'-8" 15'-8"

1.12

172 SF

1.25

OVER LAND PORTION

LANDSCAPE AREA

FLOOR AREA RATIO (FAR)

PLANTERS AT 1ST FLOOR

1'-0" 1'-0" SIDE [PROJECT NORTH] SIDE [PROJECT SOUTH] 5'-0" AVG 2'-9" 26'-0" BUILDING HEIGHT ABOVE A.N.G. ~24'-7 1/2" AVERAGE NATURAL GRADE REFER TO SURVEY SHEET ADJACENT USES NORTH RESTAURANT / RETAIL

WEST N/A - WATER

EAST RESTAURANT / RETAIL

SOUTH PLAZA (RESTAURANT / RETAIL)

BUILDING SUMMARY

	EXISTING	PROPOSED
OCCUPANCY	A-2	A-2, B, R-1
CONSTRUCTION TYPE	V-B	V-B
NO. STORIES	2 WITH BASEMENT	2 WITH BASEMENT
NO. UNITS	(1) BAR/RESTAURANT	(1) BAR/RESTAURANT (1) COFFEE SHOP (7) HOTEL ROOMS
SPRINKLERS	Y	Y

PARKING ANALYSIS

REQUIRED PARKING CALCULATIONS		
RESTAURANT		
1 SPACE PER 60 SF OF CUSTOMER AREA		
DINING	1338	22.3
COVERED OUTDOOR DINING	751	12.5
COFFEE SHOP	553	9.2
BANQUET	324	5.4
•	TOTAL	49.4
UNCOVERED OUTDOOR DINING		
1 SPACE PER 120 SF OF CUSTOMER AREA		
FRONT PATIO DINING	676	5.6
REAR PATIO DINING	261	2.2
	TOTAL	7.8
HOTEL		
1 SPACE PER UNIT PLUS 1 SPACE FOR EACH 10 ROOMS		
(7) UNITS	1 x 7	7
	.1 * 7	.7
1.	TOTAL	7.7
BOAT SLIPS		
1 SPACE PER 35' OF TIE DOWN AREA		
35' TIE DOWN AREAS	2	2
	TOTAL	2
TOTALS	'	
TOTAL SPACES REC	UIRED	66.9
HISTORIC PARKING CREDITS AVA	79	
LOADING		
10' x 35' Loading Zone	1	

VICINITY MAP



IMPERVIOUS SURFACE **EXISTING** LAND PORTION OF 5,430 SF 6,200 SF TOTAL CHANGE 770 SF

PROPOSED SIGNIFICANT BENEFITS

- ADD'L 5FT HARBORWALK WIDTH (APPROX 300 SF) - PUBLIC ACCESS TO NEW PRIVATE DOCK - LIMITED PUBLIC ACCESS TO 2ND FLOOR VIEW DECK - PUBLIC SIDEWALK/GUTTER IMPROVEMENTS ALONG EMBARCADERO STREET ALONG WIDTH OF PROPOSED PLAZA - NEW LOADING/DROP-OFF AREA - DESIGN FOR PUBLIC PLAZA
- ADDITIONAL PUBLIC BENEFITS WITH APPROVAL TO USE PLAZA FOR PUBLIC
- METERED ELECTRICAL CONNECTIONS AT THREE LOCATIONS ACROSS
- METERED WATER CONNECTIONS AT TWO LOCATIONS ACROSS PLAZA - REMOVAL OF HARDSCAPE AND ASPHALT PAVING AT PLAZA AREA - CONCRETE CURB TRANSITIONS AND STABILIZED DG SURFACING ACROSS PLAZA AREA
- RECONFIGURE CURB DI DRAINAGE THROUGH PLAZA AREA - PERFORM ANY ADDITIONAL IMPROVEMENTS REQUESTED BY CITY PAIL FOR BY ADJACENT LEASE SITES OR CITY, CAN BE PERFORMED DURING THE CONSTRUCTION PHASE

EQUESTED EXCEPTIONS

- HEIGHT EXCEPTION: PROPOSED BUILDING EXCEEDS 17FT - PROPOSED BUILDING SHALL NOT EXCEED 25FT
- 2ND FLOOR SETBACK AT STREET FRONTAGE/RIGHT OF WAY - 10FT REQUIRED, 0FT PROPOSED, TO MAINTAIN TWO-STORY VOLUME SIMILAR TO EXISTING BUILDING
- FRONT FACE IS BROKEN UP BY BALCONY/AWNING - MINOR VIEW CORRIDOR ENCROACHMENT AT SOUTHWEST CORNER - LEASE LINE ADJUSTMENT MITIGATES MUCH OF THE CONCERN - ADDITIONAL GLAZING AT SOUTHWEST CORNERS MAINTAINS VIEW THROUGH BUILDING

OTE: WE ARE PROPOSING A LEASE LINE ADJUSTMENT, THE EXTENTS OF HICH ARE INDICATED ON THE PROPOSED SITE PLAN, SHEET A1.1. ALL ALCULATIONS ARE BASED ON THE PROPOSED LEASE LINE ADJUSTMENT

SHEET INDEX

RCHITECTURAL

0.1 COVER SHEET

- DOCK/PILE PLAN SITE PLAN & GENERAL NOTES DOCK/PILE PLAN - CONSTRUCTION PLAN
- SURVEY
- 1.1 SITE PLAN
- 1.2 FRIDAY / SATURDAY PROPOSED CONCERT LAYOUT PLAN
- 1.3 LANDSCAPE PLANS
- A1.4 LIGHTING PLANS
- A2.1 DEMO PLAN A2.2 FLOOR PLANS
- A2.3 FLOOR AND ROOF PLAN
- A5.1 BUILIDNG ELEVATIONS
- A5.2 ELEVATIONS WITH CONTEXT A6.1 SECTIONS
- A7.1 SCHEDULES
- A8.1 SIGNAGE A9.1 PROJECT IMAGES
- A9.2 PROJECT IMAGES

TOTAL SHEETS: 18

DIRECTORY


CALIFORNIA COASTAL INVESTMENTS 2436 BROAD ST SAN LUIS OBISPO, CA TEL: 805-544-5583 REP: ERIC NEWTON EMAIL: admin@newtonconstruction.com

DESIGN BY: OUTLIER 418 BROADWAY CHICO, CA

TEL: 805.791.7610

EMAIL: trevor@otlr.co

HAB DESIGN GROUP 330 S HALCYON RD ARROYO GRANDE, CA 93420 805-544-4334 REP: TREVOR MILLER, AIA REP: C.J. HORSTMAN, AIA EMAIL: c.horstman@habgroup.net

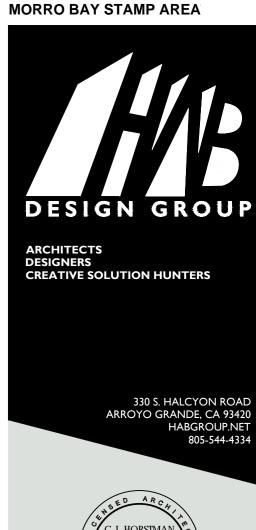

ARCHITECT OF RECORD

SH 801 EAS

SHEET

LTITLE-THESE DRAWINGS ARE INSTRUMENTS OF SERVICE AND ARE THE COMMON COPYRIGHT AND OTHER PROPERTY RIGHTS RESERVE THIS DOCUMENT SHALL NOT BE DUPLICATED, COPIED, DISCLOSI OR USED IN CONNECTION WITH ANY WORK OR PROJECT OTHER THAN THE SPECIFIC PROJECT FOR WHICH IT HAS BEEN PREPARI OR ASSIGNED TO ANY THIRD PARTY WITHOUT FIRST OBTAINING THE EXPRESS WRITTEN CONSENT OF OTLR. VISUAL CONTACT WITHIS DOCUMENT SHALL CONSTITUTE CONCLUSIVE EVIDENCE OF CCEPTANCE OF THESE RESTRICTIONS.

REVISION HISTORY							
NO.	DESC.	DATE					
	·						

APP# APN# 006-322-008 JOB# 20-185 DATE 2023-11-01 TW CHECKED

SHEET NUMBER

Exhibit 3 3-24-0149

SYMBOL LEGEND

MATERIAL NUMBER

COLOR DESIGNATION

KEYNOTE NUMBER

DOOR NUMBER

WINDOW NUMBER

VIEW DIRECTION


DETAIL NUMBER


DRAWING SHEET


DETAIL NUMBER


DRAWING SHEET

GRID NUMBER

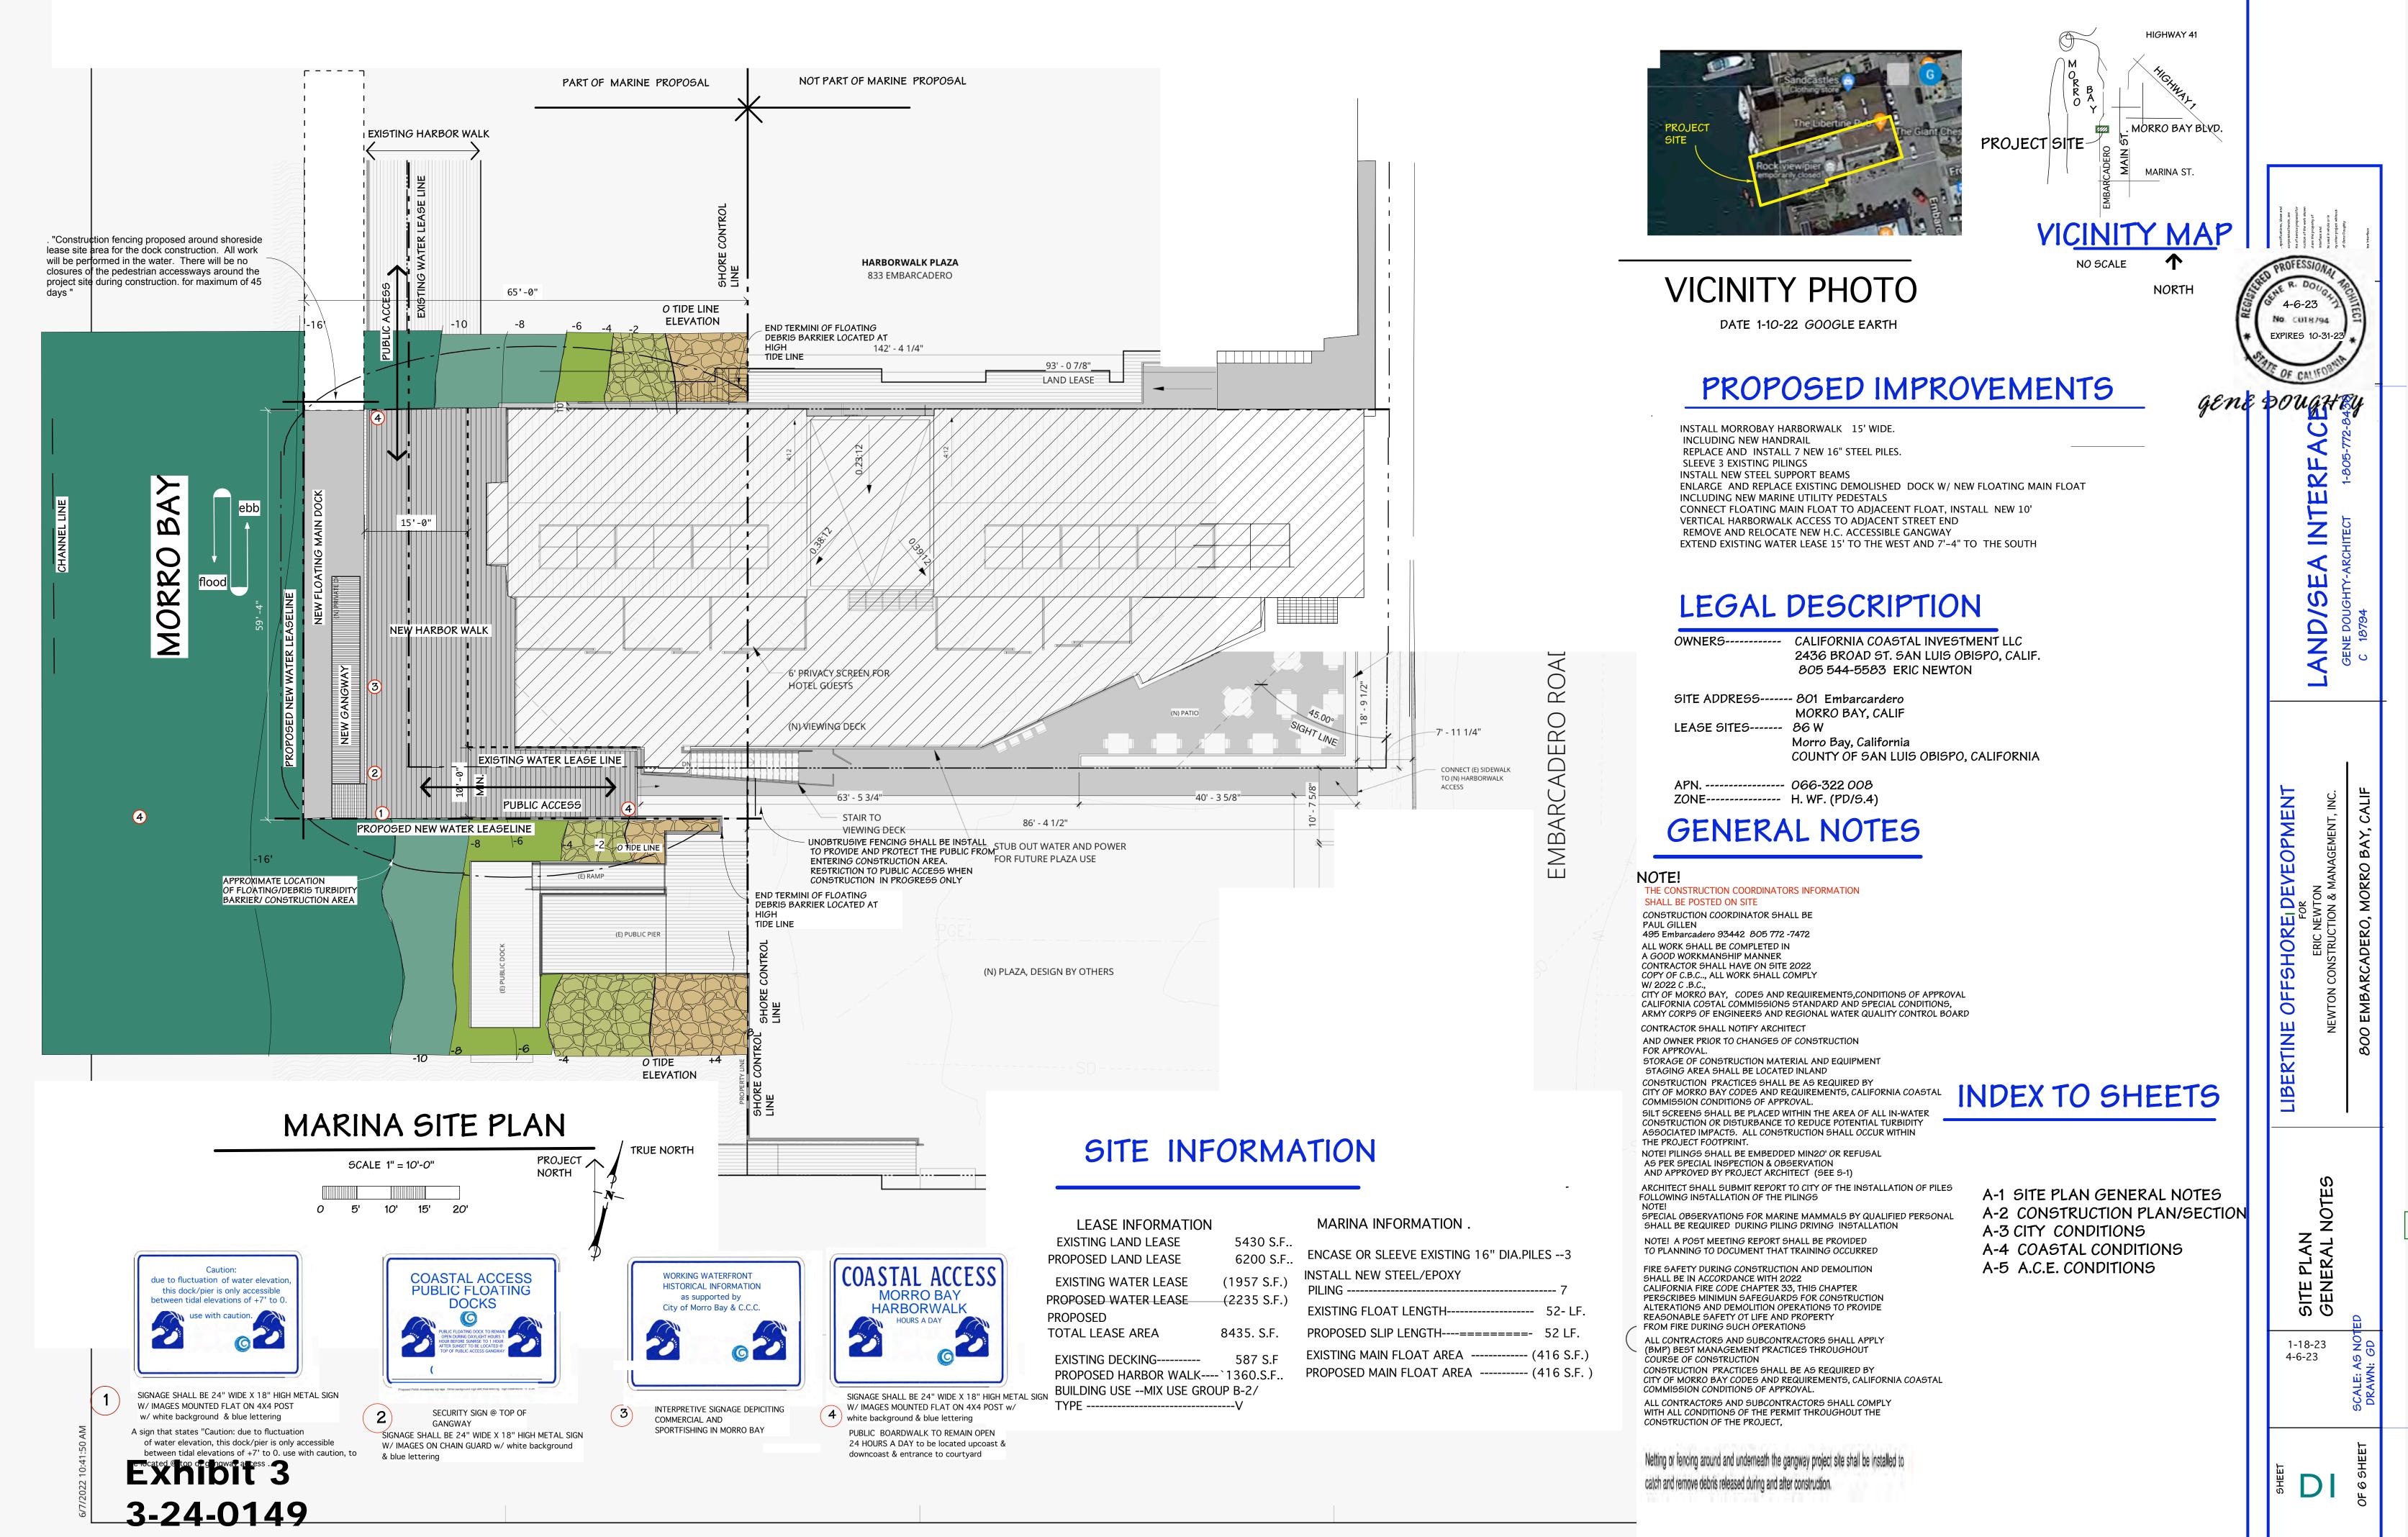

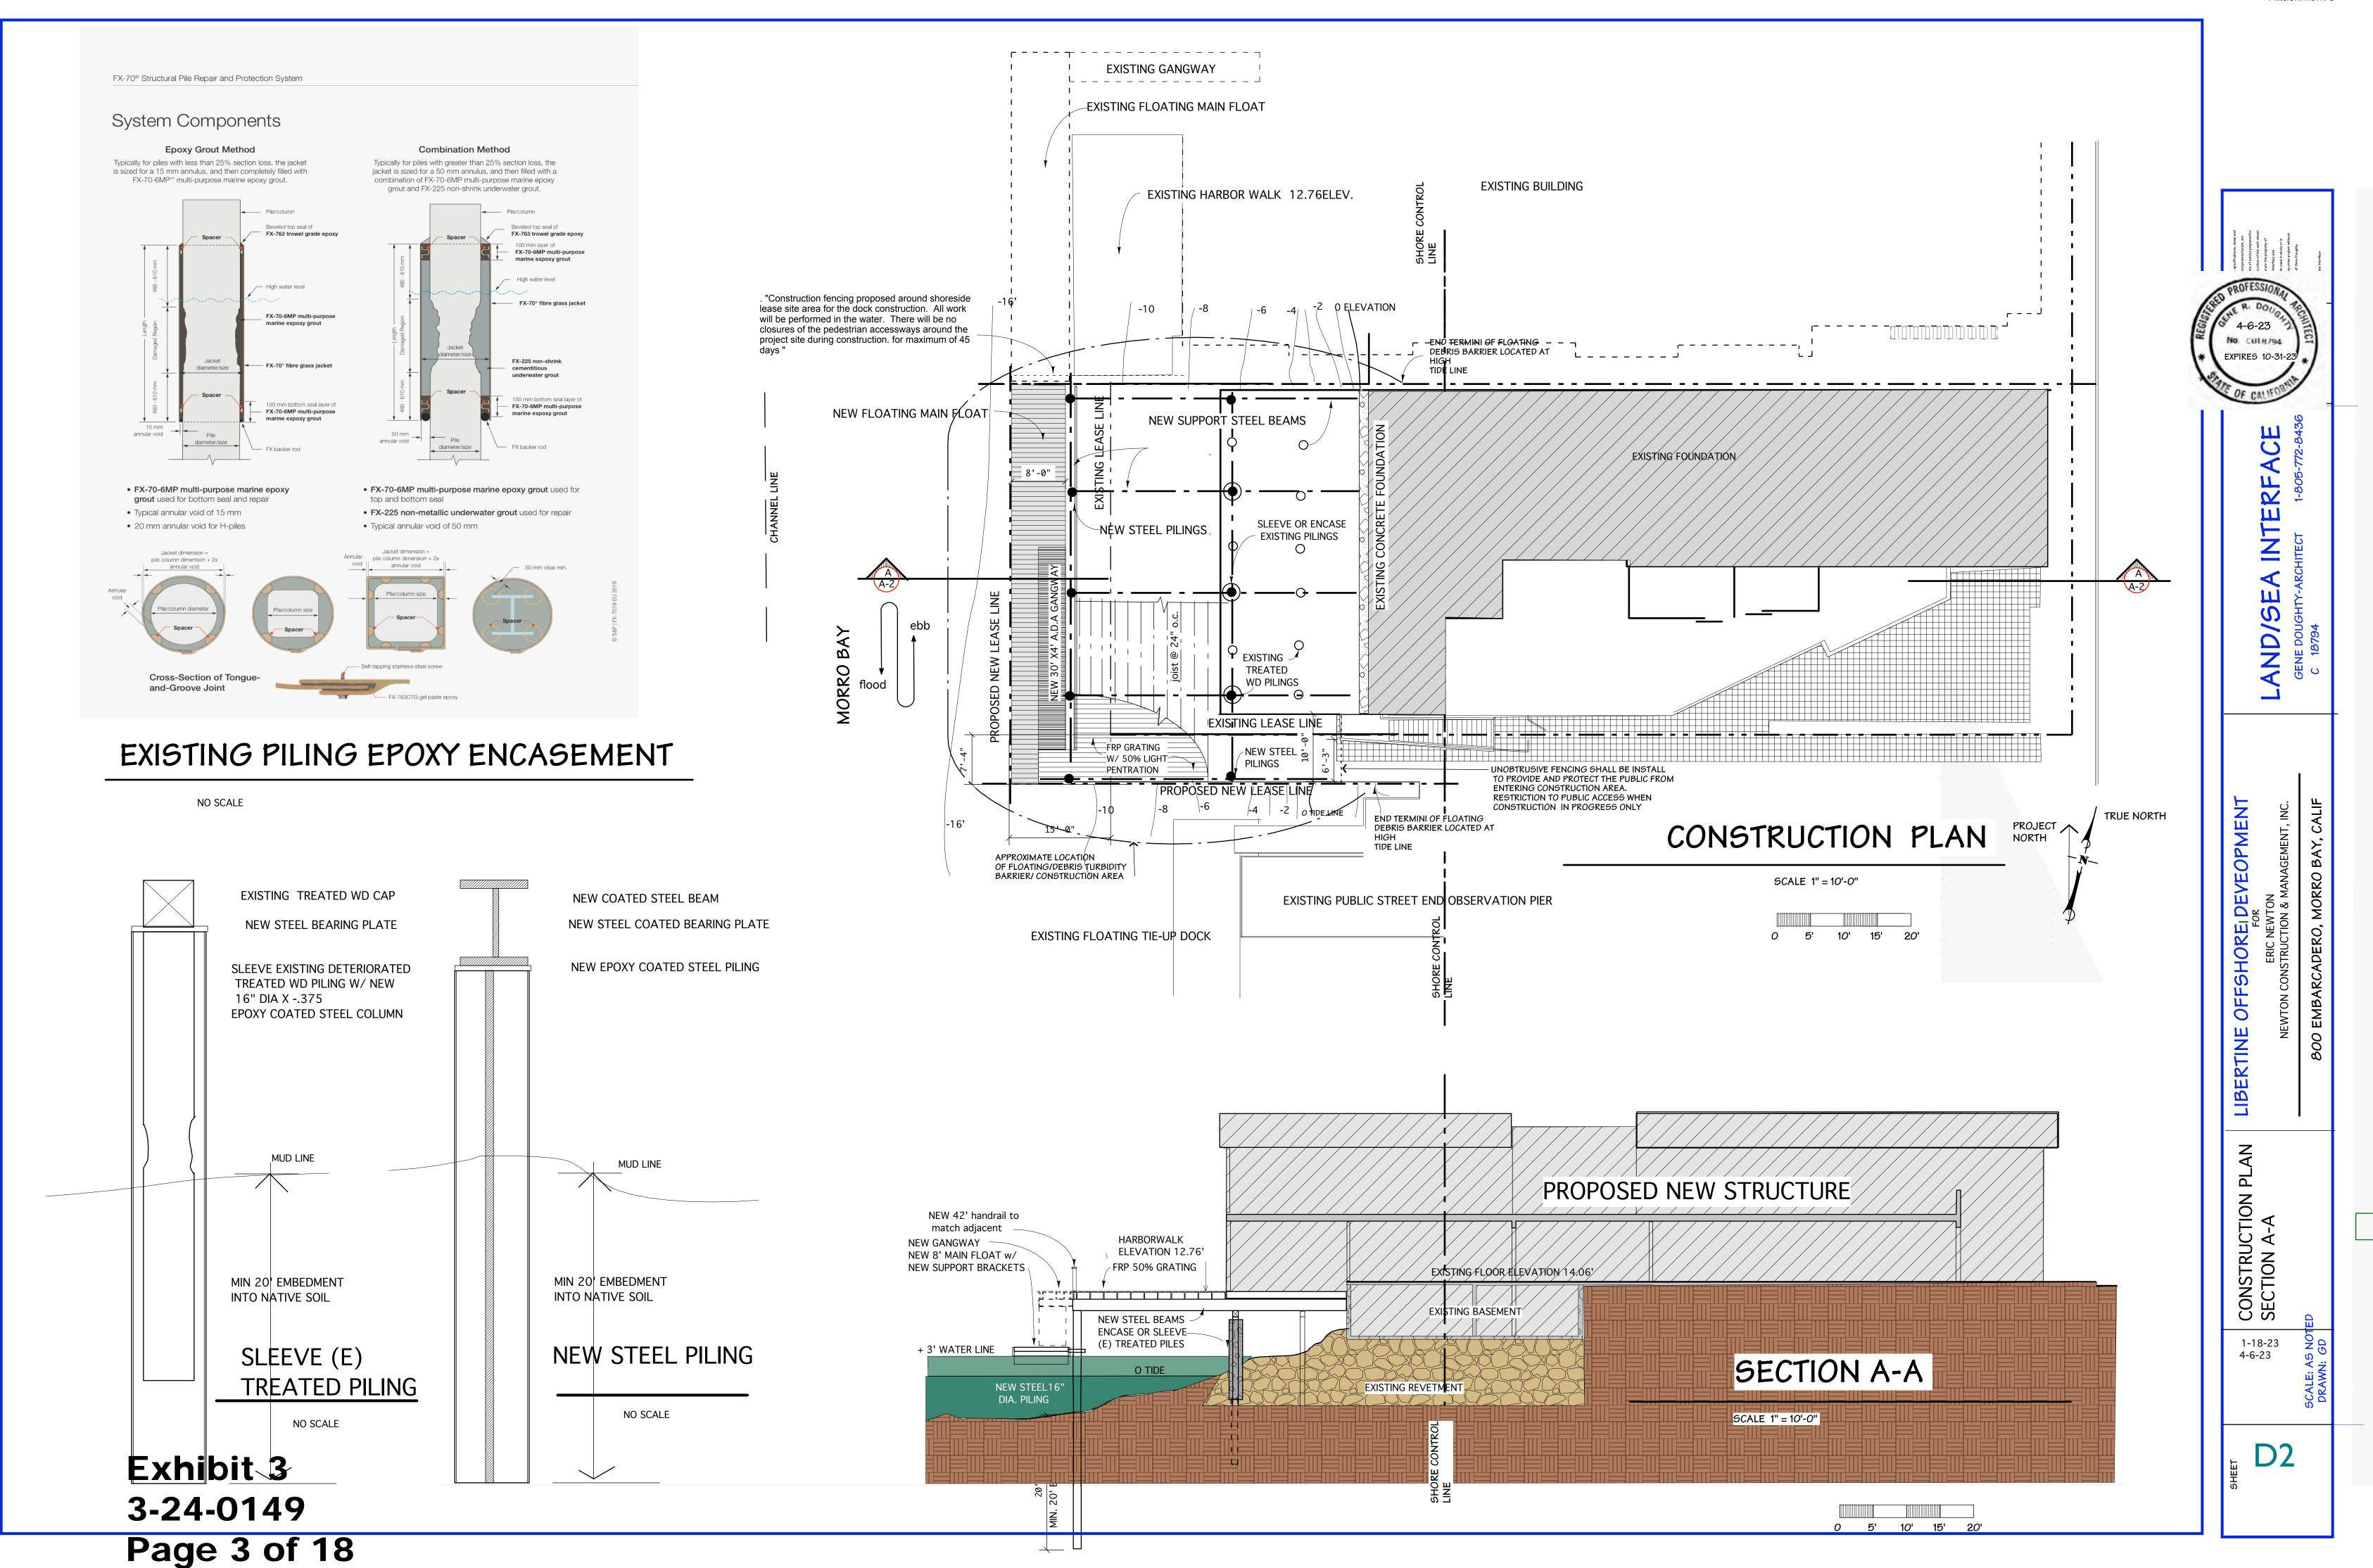

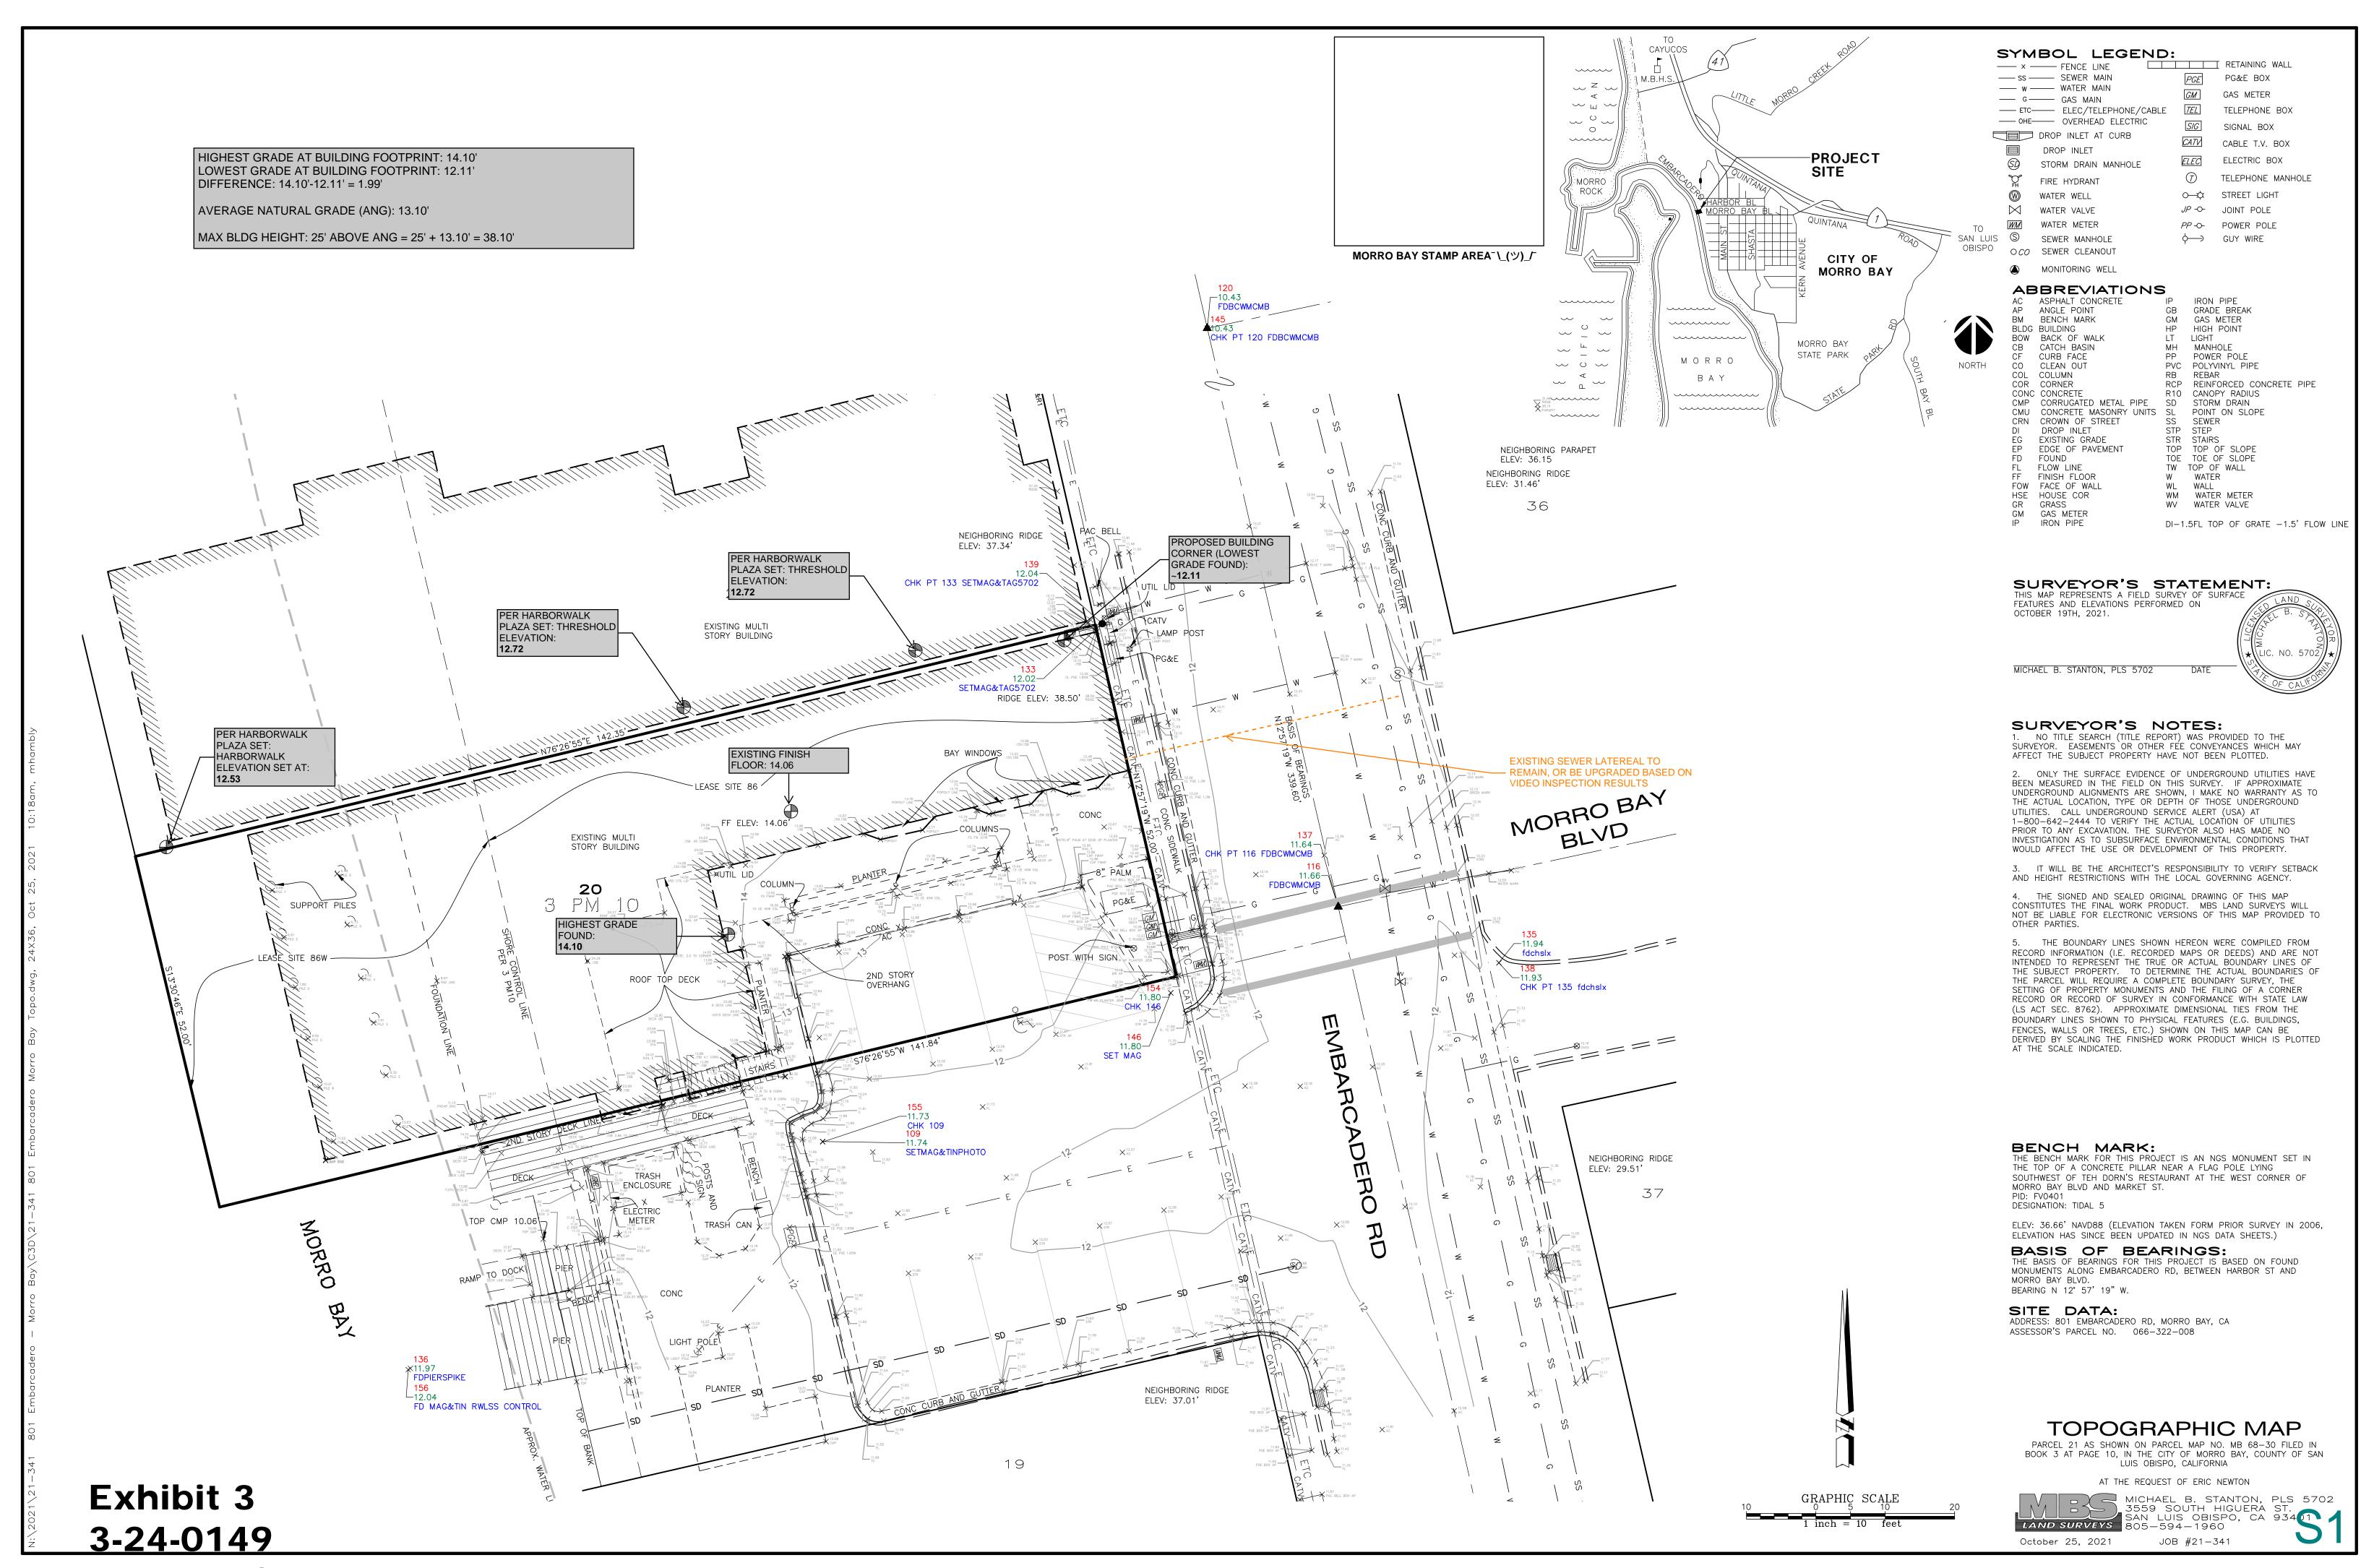

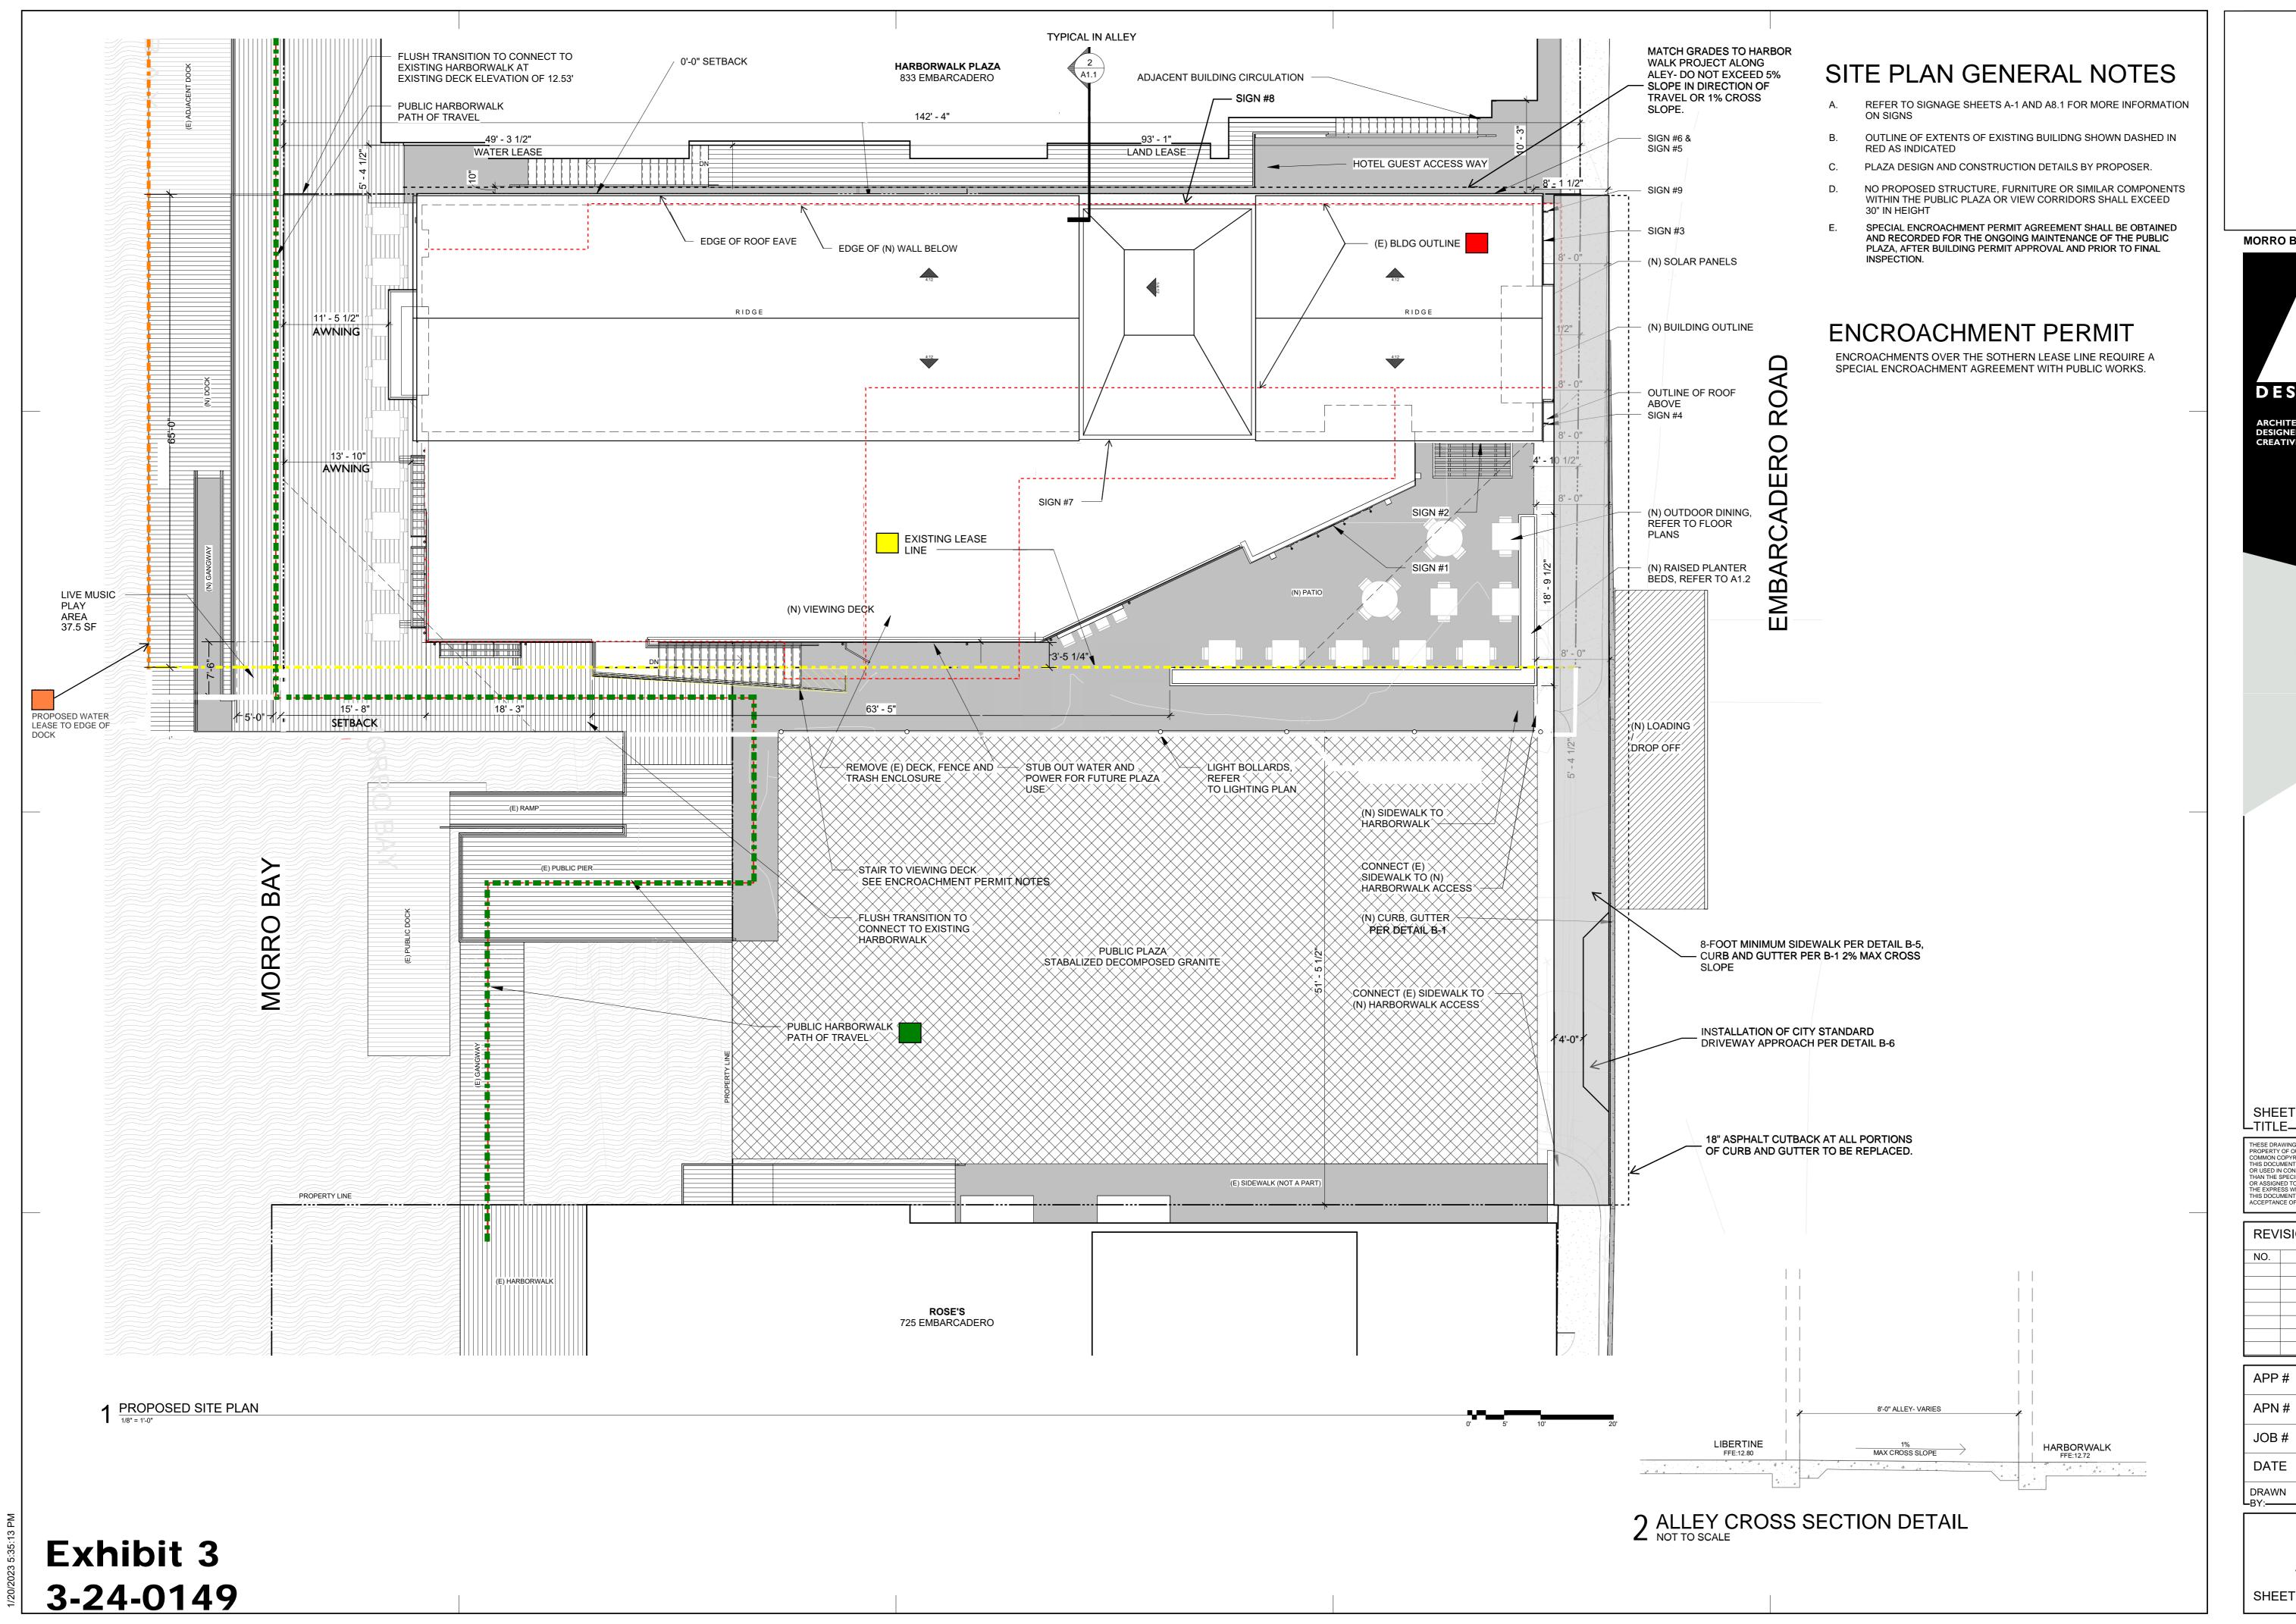

Page 5 of 18

MORRO BAY STAMP AREA



ARCHITECT OF RECORD

SITE PLAN
LIBERTINE MORRO BAY
801 EMBARCADERO
LEASE SITES 86 & 86W

THESE DRAWINGS ARE INSTRUMENTS OF SERVICE AND ARE THE PROPERTY OF OUTLIER/TREVOR MILLER ARCHITECT (OTLR), ALL COMMON COPYRIGHT AND OTHER PROPERTY RIGHTS RESERVED. THIS DOCUMENT SHALL NOT BE DUPLICATED, COPIED, DISCLOSED, OR USED IN CONNECTION WITH ANY WORK OR PROJECT OTHER THAN THE SPECIFIC PROJECT FOR WHICH IT HAS BEEN PREPARED, OR ASSIGNED TO ANY THIRD PARTY WITHOUT FIRST OBTAINING THE EXPRESS WRITTEN CONSENT OF OTLR. VISUAL CONTACT WITH THIS DOCUMENT SHALL CONSTITUTE CONCLUSIVE EVIDENCE OF ACCEPTANCE OF THESE RESTRICTIONS.

REVISION HISTORY

NO. DESC. DATE

APP # --APN # 006-322-008

JOB # 20-185


DATE 2023-11-01

DRAWN TW CHECKED TM
BY: CHECKED TM

A1.1
SHEET NUMBER

330 S. HALCYON ROAD ARROYO GRANDE, CA 93420 HABGROUP.NET

ARCHITECT OF RECORD

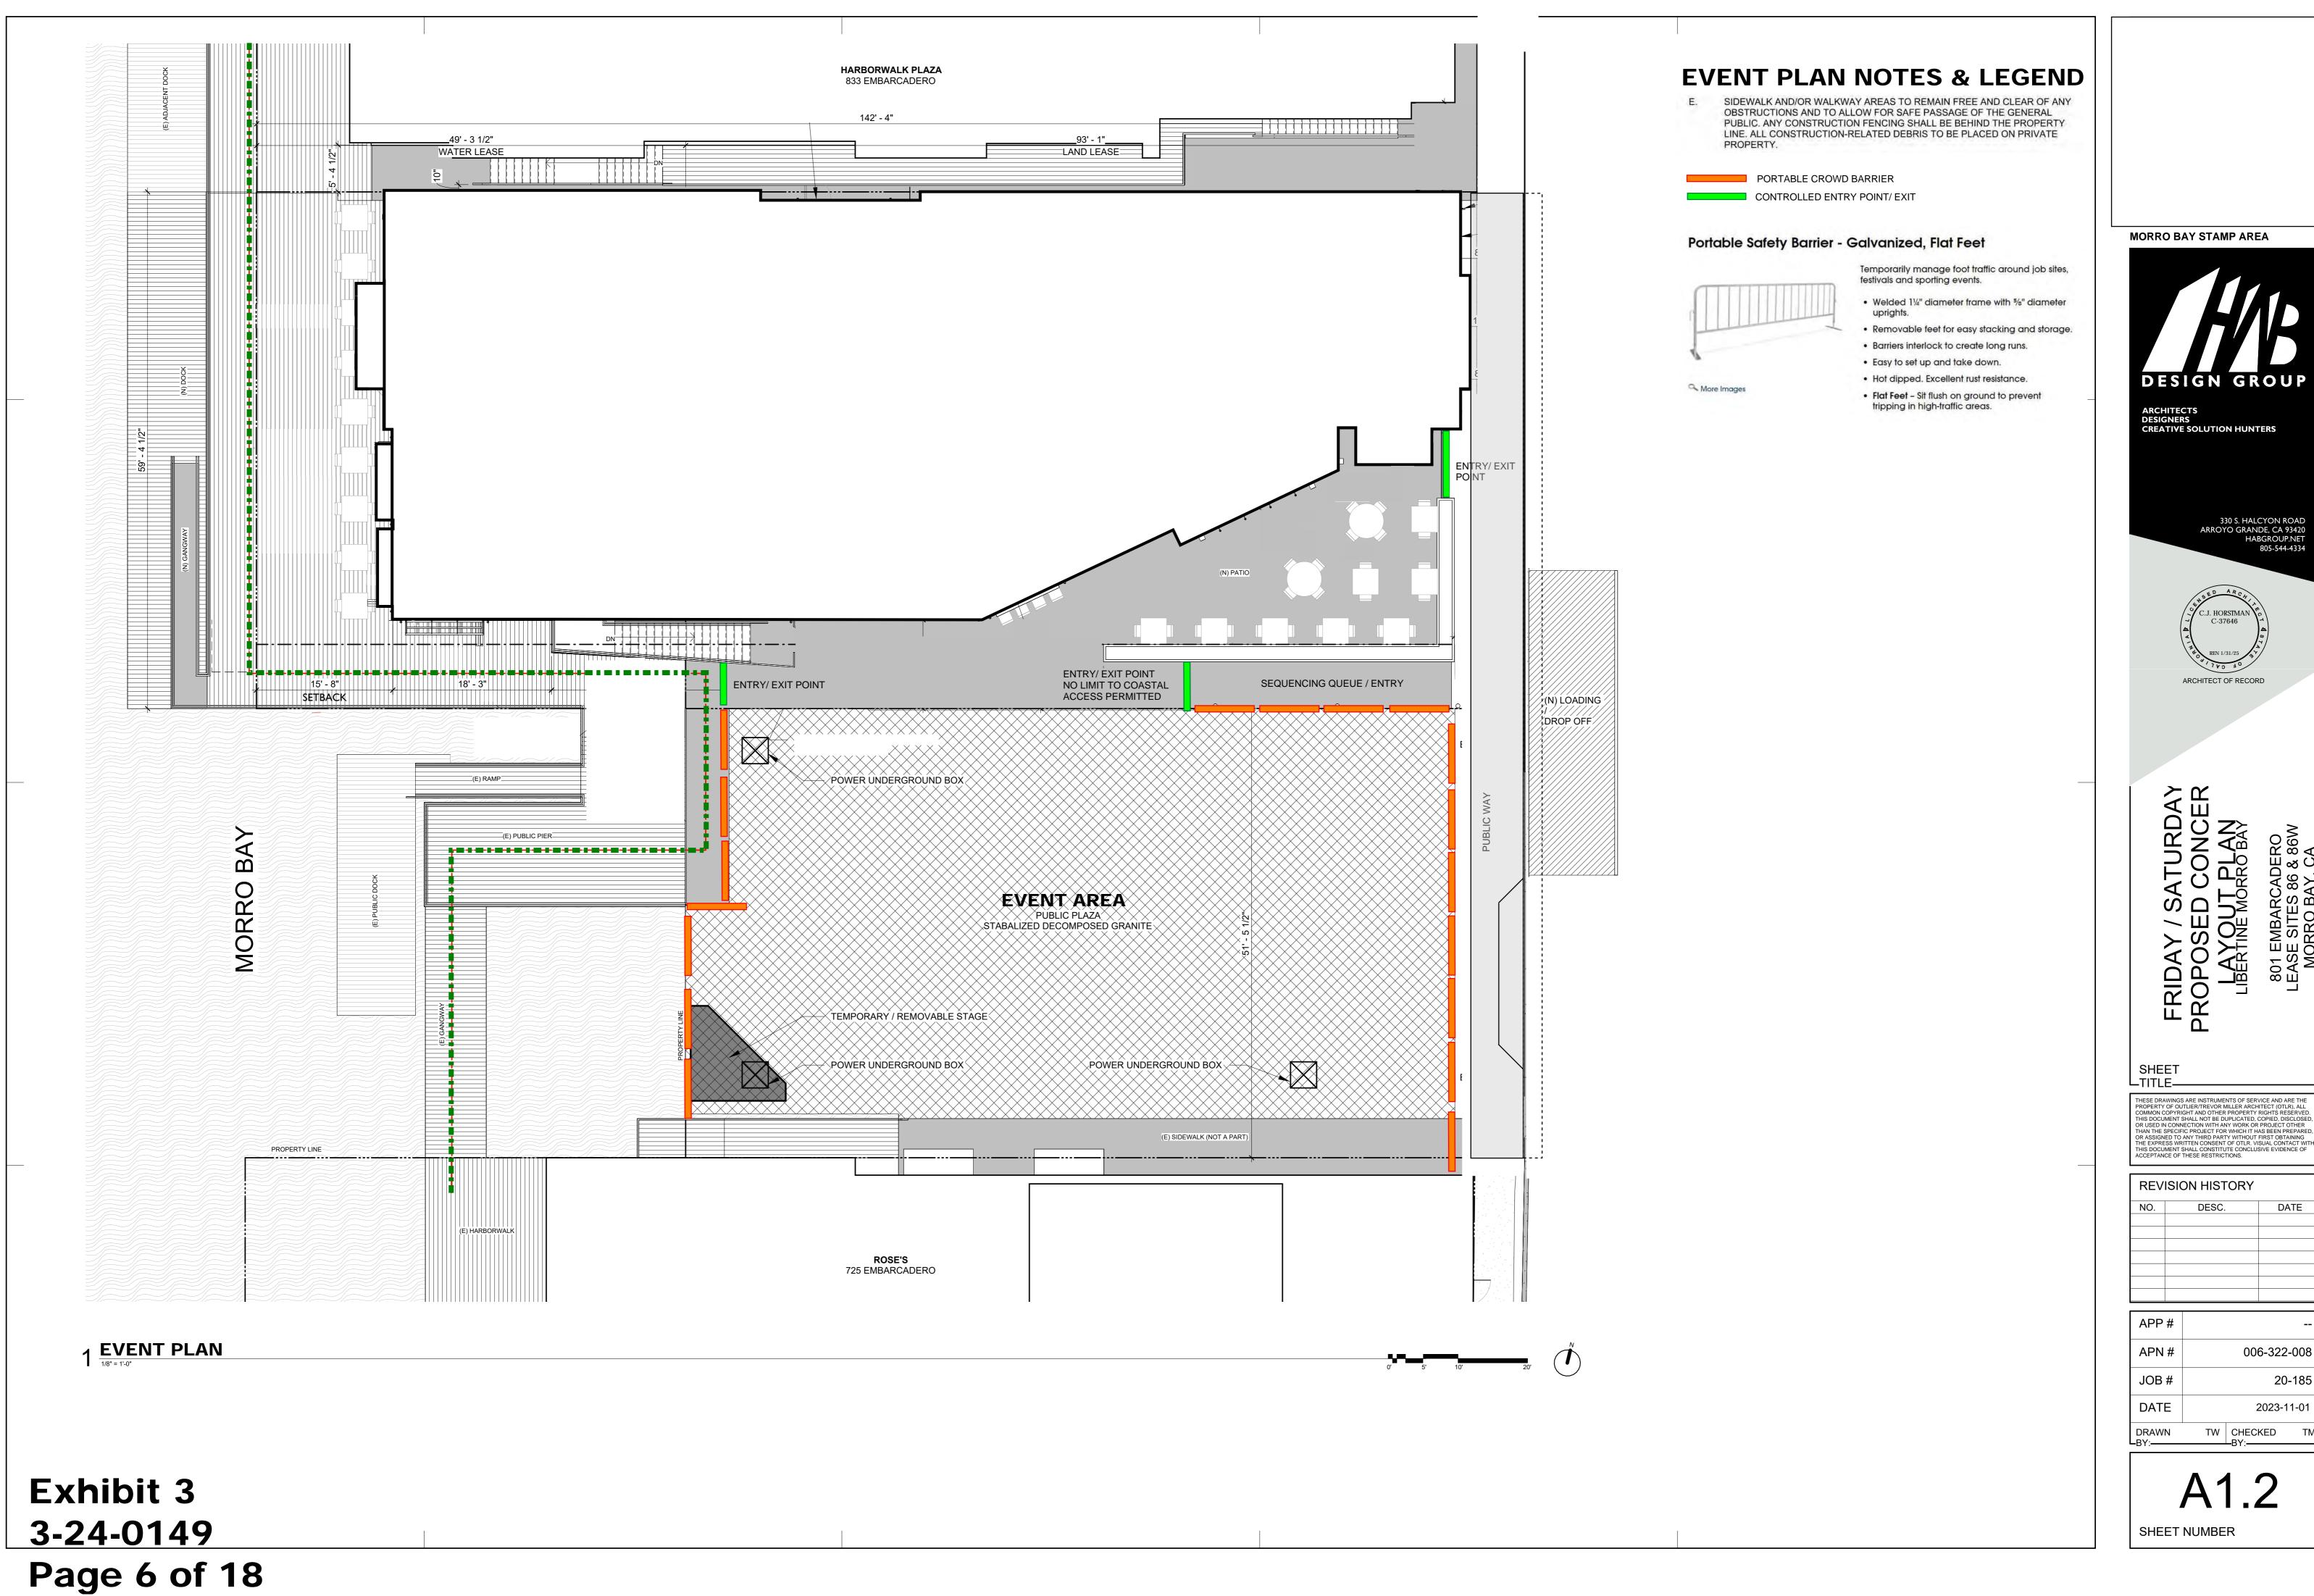


SHEET NUMBER

006-322-008


20-185

2023-11-01


TW CHECKED

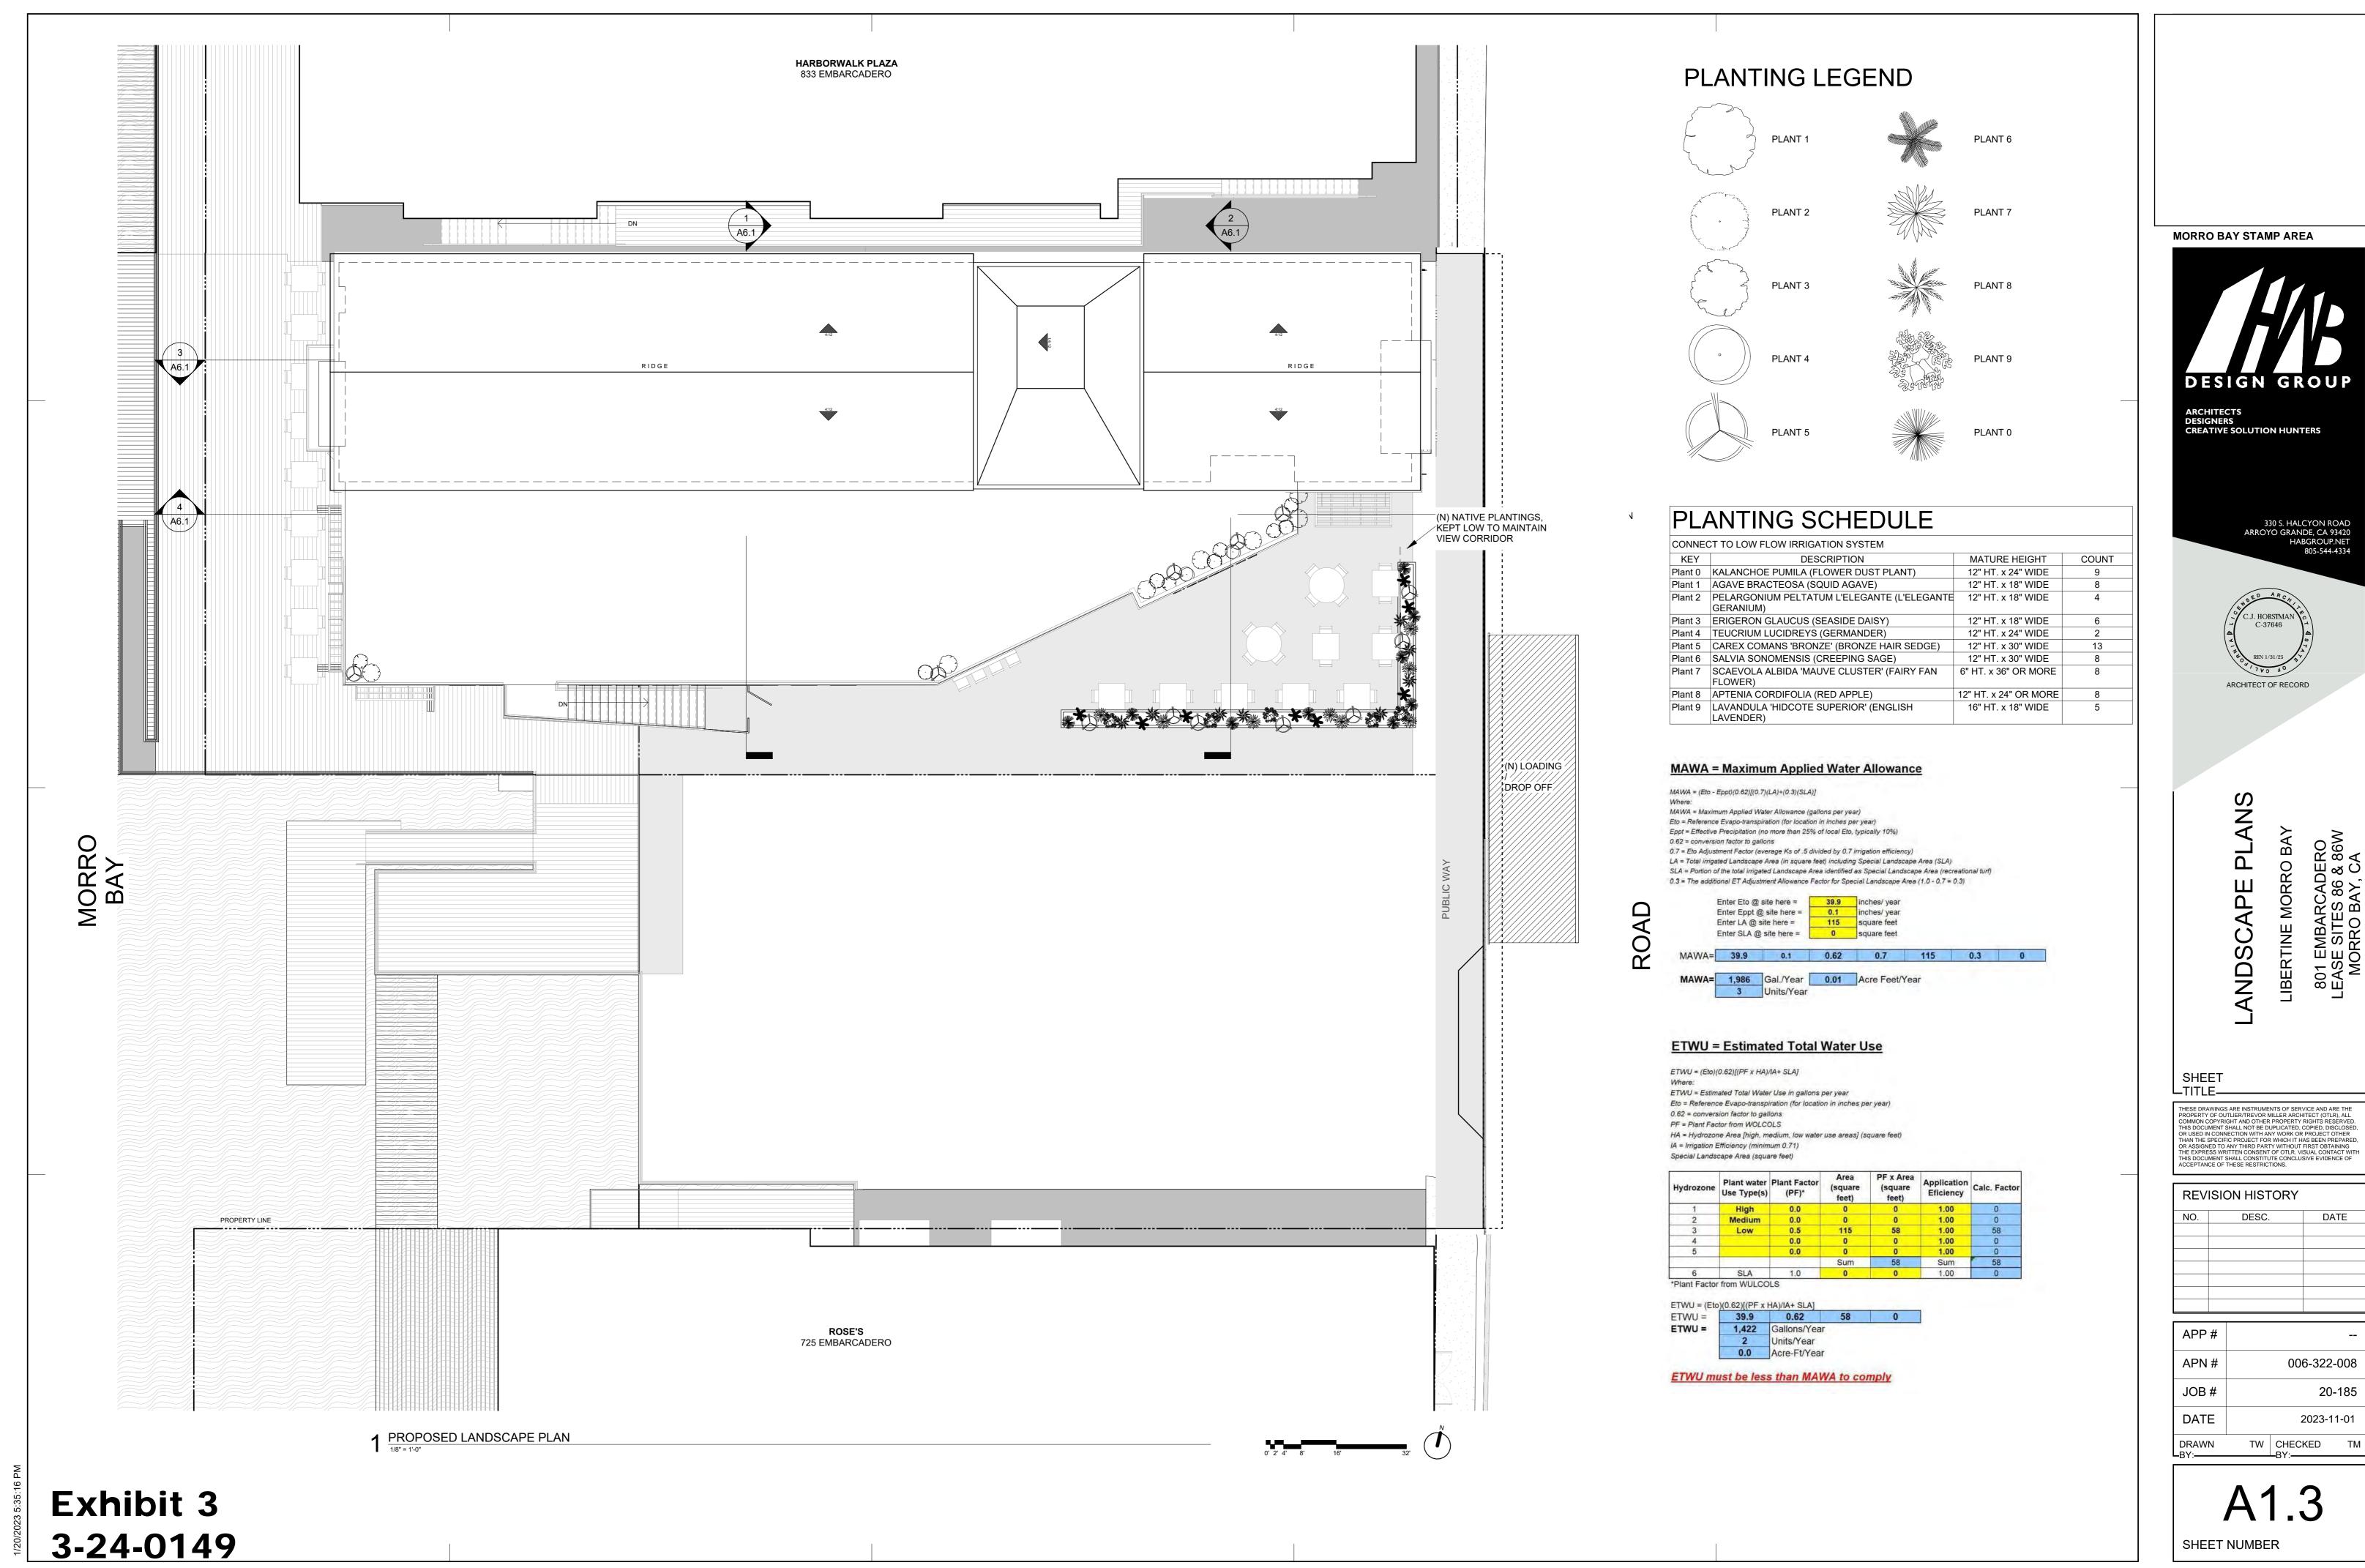

Page 7 of 18

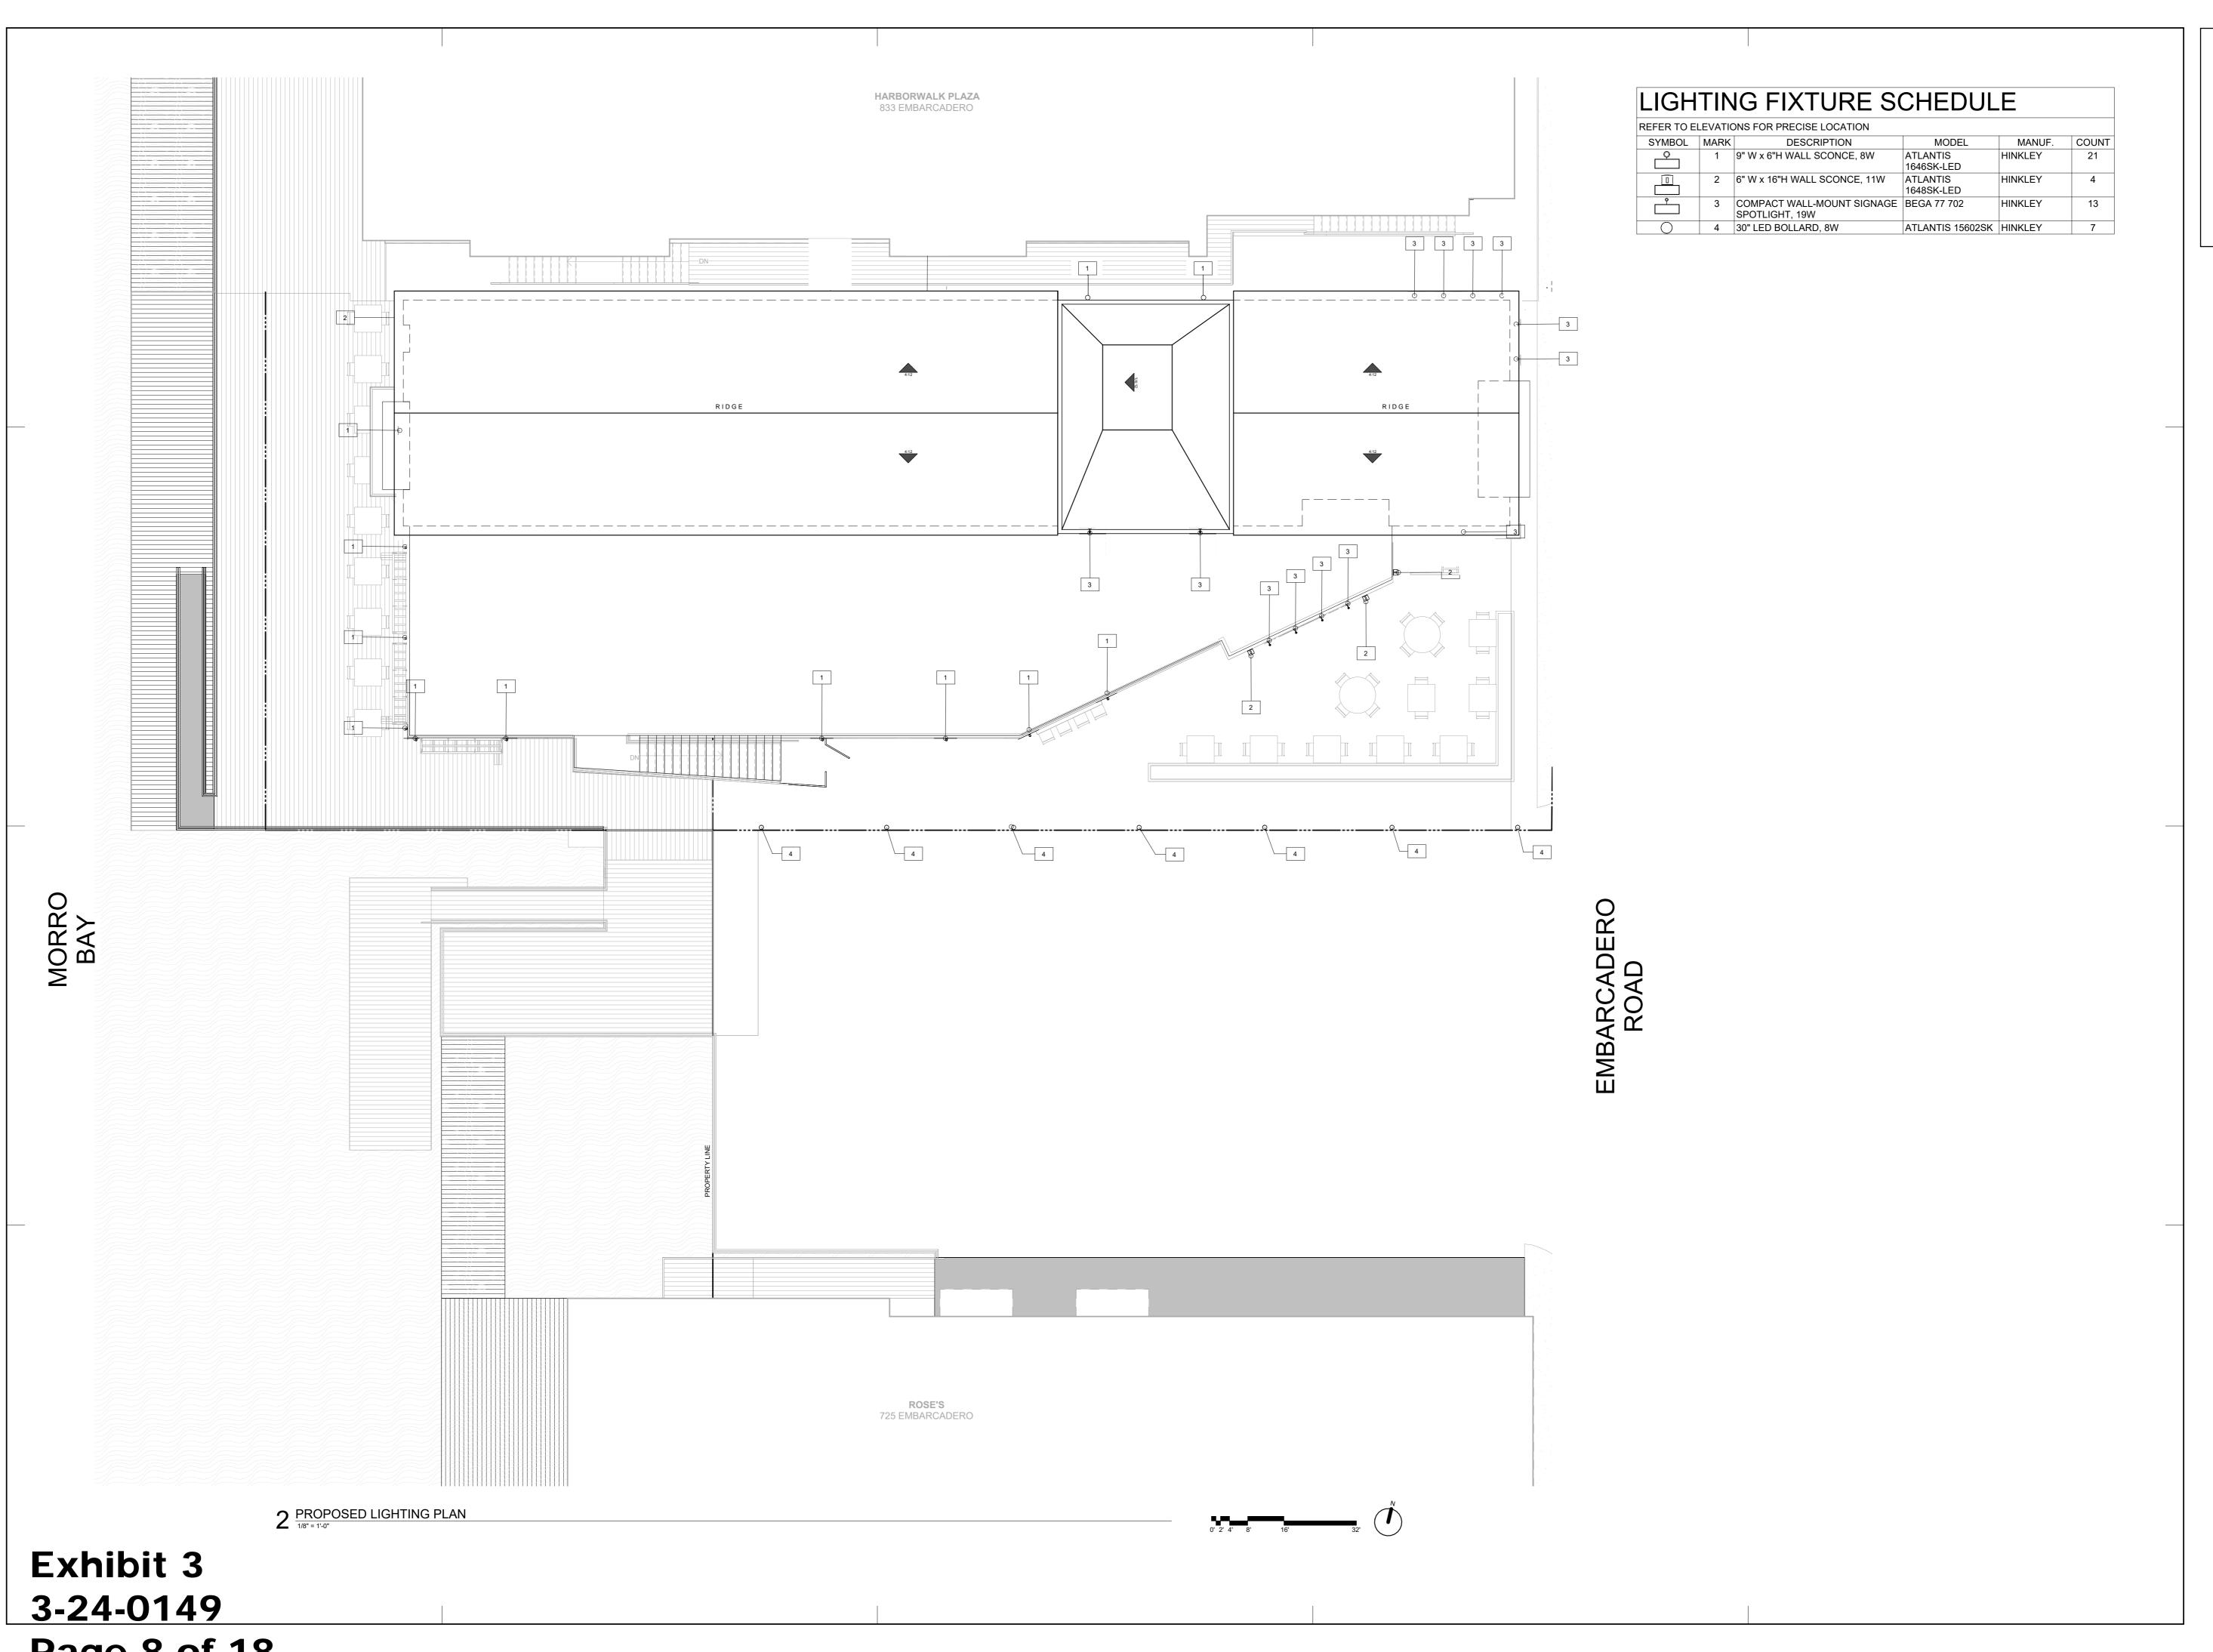

MORRO BAY STAMP AREA

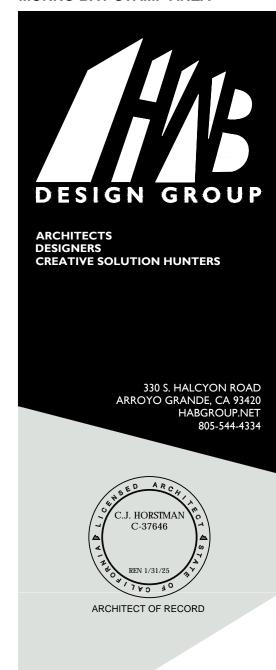

LIGHTING PLAN


THESE DRAWINGS ARE INSTRUMENTS OF SERVICE AND ARE THE PROPERTY OF OUTLIER/TREVOR MILLER ARCHITECT (OTLR), ALL COMMON COPYRIGHT AND OTHER PROPERTY RIGHTS RESERVED. THIS DOCUMENT SHALL NOT BE DUPLICATED, COPIED, DISCLOSED, OR USED IN CONNECTION WITH ANY WORK OR PROJECT OTHER THAN THE SPECIFIC PROJECT FOR WHICH IT HAS BEEN PREPARED, OR ASSIGNED TO ANY THIRD PARTY WITHOUT FIRST OBTAINING THE EXPRESS WRITTEN CONSENT OF OTLR. VISUAL CONTACT WITH THIS DOCUMENT SHALL CONSTITUTE CONCLUSIVE EVIDENCE OF ACCEPTANCE OF THESE RESTRICTIONS.

SHEET

REVISION HISTORY

APP# 006-322-008 APN# JOB# 20-185 DATE 2023-11-01 TW CHECKED

SHEET NUMBER

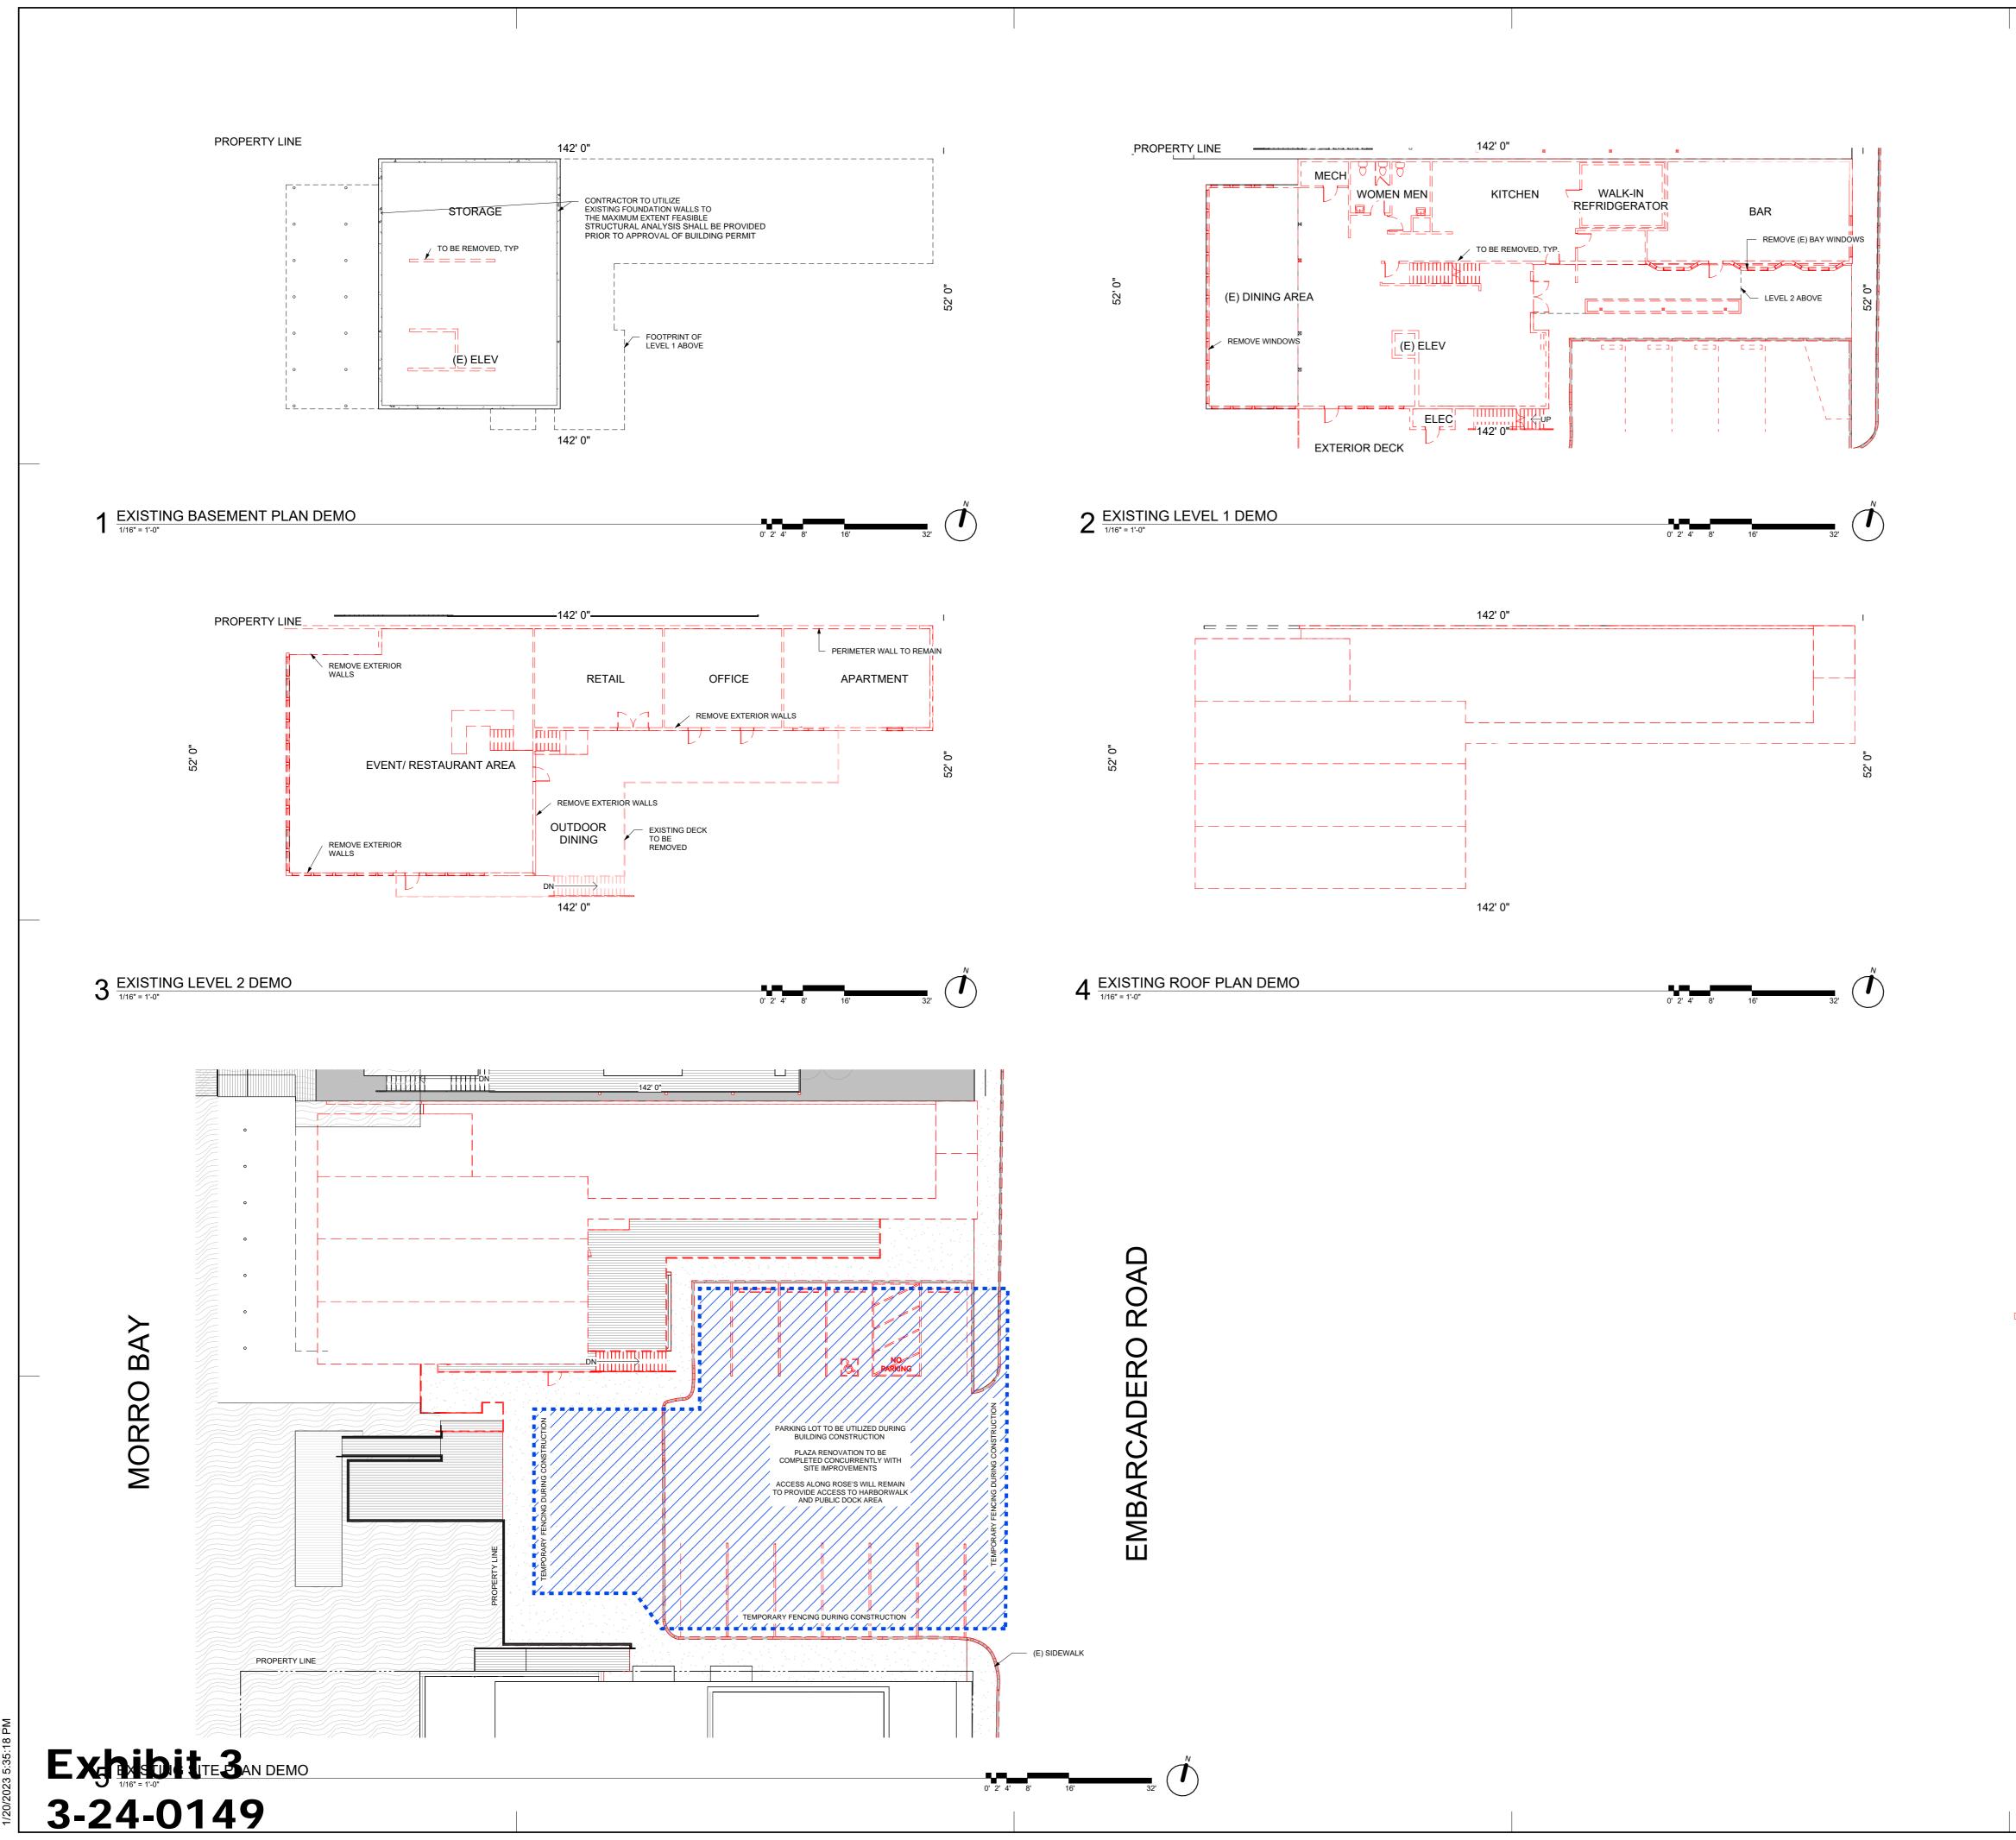

DEMOLITION GENERAL NOTES

- A. ALL WORK SHALL CONFORM TO ALL REGULATIONS, CODES AND ORDINANCES ADOPTED BY THE STATE AND LOCAL GOVERNING AGENCIES; ANY SPECIAL CONDITIONS REQUIRED BY STATE AND/OR LOCAL GOVERNING AGENCIES; AND ALL REGULATIONS AND ORDINANCES REQUIRED BY FEDERAL GOVERNING AGENCIES. CODE REFERENCED IN THIS SUBMITTAL: 2007 CALIF. BLDG CODE
- B. ALL WORK DESCRIBED IN THE DRAWINGS SHALL BE VERIFIED BY THE CONTRACTOR FOR DIMENSION, GRADE, EXTENT AND COMPATIBILITY TO THE FIELD CONDITIONS. ANY DISCREPANCIES AND UNEXPECTED CONDITIONS THAT AFFECT OR CHANGE THE WORK DESCRIBED IN THESE DRAWINGS SHALL BE BROUGHT TO THE DESIGNERS ATTENTION IMMEDIATELY. DO NOT PROCEED WITH THE WORK IN THE AREA OF DISCREPANCIES UNTIL ALL SUCH DISCREPANCIES ARE RESOLVED.
- C. DIMENSIONS SHOWN SHALL TAKE PRECEDENCE OVER DRAWING SCALE OR PROPORTION. LARGER SCALE DRAWINGS SHALL TAKE PRECEDENCE OVER SMALLER SCALE DRAWINGS
- WHERE DEMOLITION IS INDICATED, CONTRACTOR SHALL DISCONNECT AND CAP ALL UTILITIES, ELECTRICAL CONDUITS, ETC. PER CODE, WHERE SUCH ITEMS ARE NOT INDICATED TO BE REUSED. CAP ALL ABANDONED PENETRATIONS ABOVE FINISHED CEILING.
- E. CONTRACTOR TO NOTIFY OWNER PRIOR TO COMMENCING WITH ANY WORK. CONTRACTORS SHALL CONFORM TO ANY REQUIREMENTS FOR NOISE AND DUST CONTROL, TRASH, STORAGE WORK HOURS, SITE ACCESS, ETC. AS DIRECTED BY THE OWNER.
- F. CONTRACTOR IS RESPONSIBLE FOR REPAIR, REPLACEMENT OR CLEAN UP OF ANY DAMAGE CAUSED BY THEIR WORK TO ANY PORTION OF EXISTING IMPROVEMENTS.
- G. CONTRACTOR IS RESPONSIBLE FOR COORDINATION AND SCHEDULING OF INSPECTIONS BY THE BUILDING DEPARTMENT AND OTHER AGENCIES AS REQUIRED.
- H. REMOVE FROM SITE AND LEGALLY DISPOSE OF REFUSE, DEBRIS, RUBBISH, AND OTHER MATERIALS RESULTING FROM DEMOLITION OPERATIONS. THE SITE SHALL BE LEFT BROOM CLEAN. COORDINATE DISPOSAL LOCATION W/ PROPERTY MANAGEMENT.
- I. ARRANGE AND PAY FOR DISCONNECTING, REMOVING AND CAPPING UTILITY SERVICES WITHIN AREAS OF DEMOLITION. DISCONNECT AND STUB-OFF.
- J. CAP OFF EXISTING PLUMBING, ELECTRICAL, AND MECHANICAL NOT UTILIZED IN NEW SCHEME PER CODE AND CLEAR OF NEW WORK: CAP ABANDONED FLOOR/CEILING PENETRATIONS BELOW FINISH FLOOR OR ABOVE CEILING.
- K. CLOSE OPENINGS IN EXTERIOR SURFACES TO PROTECT EXISTING WORK FROM WEATHER AND EXTREMES OF TEMPERATURE AND HUMIDITY.
- L. REMOVE, CUT, AND PATCH WORK IN A MANNER TO MINIMIZE DAMAGE AND TO PROVIDE A MEANS OF RESTORING PRODUCTS AND FINISHES TO ORIGINAL CONDITION.
- M. REFINISH VISIBLE EXISTING SURFACES TO REMAIN IN RENOVATED ROOMS AND SPACES, TO SPECIFIED CONDITION FOR EACH MATERIAL, WITH A NEAT TRANSITION TO ADJACENT FINISHES. PATCHES SHOULD NOT BE VISIBLE FROM A DISTANCE OF FIVE FEET OR GREATER
- N. WHERE NEW WORK ABUTS OR ALIGNS WITH EXISTING, PERFORM A SMOOTH AND EVEN TRANSITION. PATCHED WORK TO MATCH EXISTING ADJACENT WORK IN TEXTURE AND APPEARANCE.
- O. WHEN FINISHED SURFACES ARE CUT SO THAT A SMOOTH TRANSITION WITH NEW WORK IS NOT POSSIBLE, TERMINATE EXISTING SURFACE ALONG A STRAIGHT LINE AT A NATURAL LINE OF DIVISION AND MAKE RECOMMENDATION TO DESIGNER/ENGINEER.
- P. DO NOT REMOVE OR ALTER STRUCTURAL COMPONENTS WITHOUT WRITTEN APPROVAL

DEMOLITION LEGEND

EXISTING WALLS TO BE REMOVED AND DISPOSED OF, CONTRACTOR TO VERIFY ALL LOAD-BEARING CONDITIONS AND PROVIDE TEMPORARY SHORING IN NECESSARY. CONTACT ARCHITECT IF ANY PROBLEMS BECOME APPARENT DURING DEMOLITION WORK.


MORRO BAY STAMP AREA

DESIGN GROUP

ARCHITECTS
DESIGNERS
CREATIVE SOLUTION HUNTERS

330 S. HALCYON ROAD ARROYO GRANDE, CA 93420 HABGROUP.NET

805-544-4334

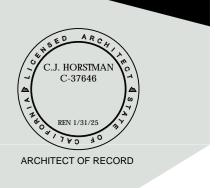

DEMO PLAN
SERTINE MORRO BAY

SHEET LTITLE

THESE DRAWINGS ARE INSTRUMENTS OF SERVICE AND ARE THE PROPERTY OF OUTLIER/TREVOR MILLER ARCHITECT (OTLR), ALL COMMON COPYRIGHT AND OTHER PROPERTY RIGHTS RESERVEE THIS DOCUMENT SHALL NOT BE DUPLICATED, COPIED, DISCLOSE OR USED IN CONNECTION WITH ANY WORK OR PROJECT OTHER THAN THE SPECIFIC PROJECT FOR WHICH IT HAS BEEN PREPARE OR ASSIGNED TO ANY THIRD PARTY WITHOUT FIRST OBTAINING THE EXPRESS WRITTEN CONSENT OF OTLR. VISUAL CONTACT WITHIS DOCUMENT SHALL CONSTITUTE CONCLUSIVE EVIDENCE OF ACCEPTANCE OF THESE RESTRICTIONS.

REVISION HISTORY

NO. DESC. DATE


APP # -
APN # 006-322-008

JOB # 20-185


DATE 2023-11-01

DRAWN TW CHECKED TM

A2.1
SHEET NUMBER

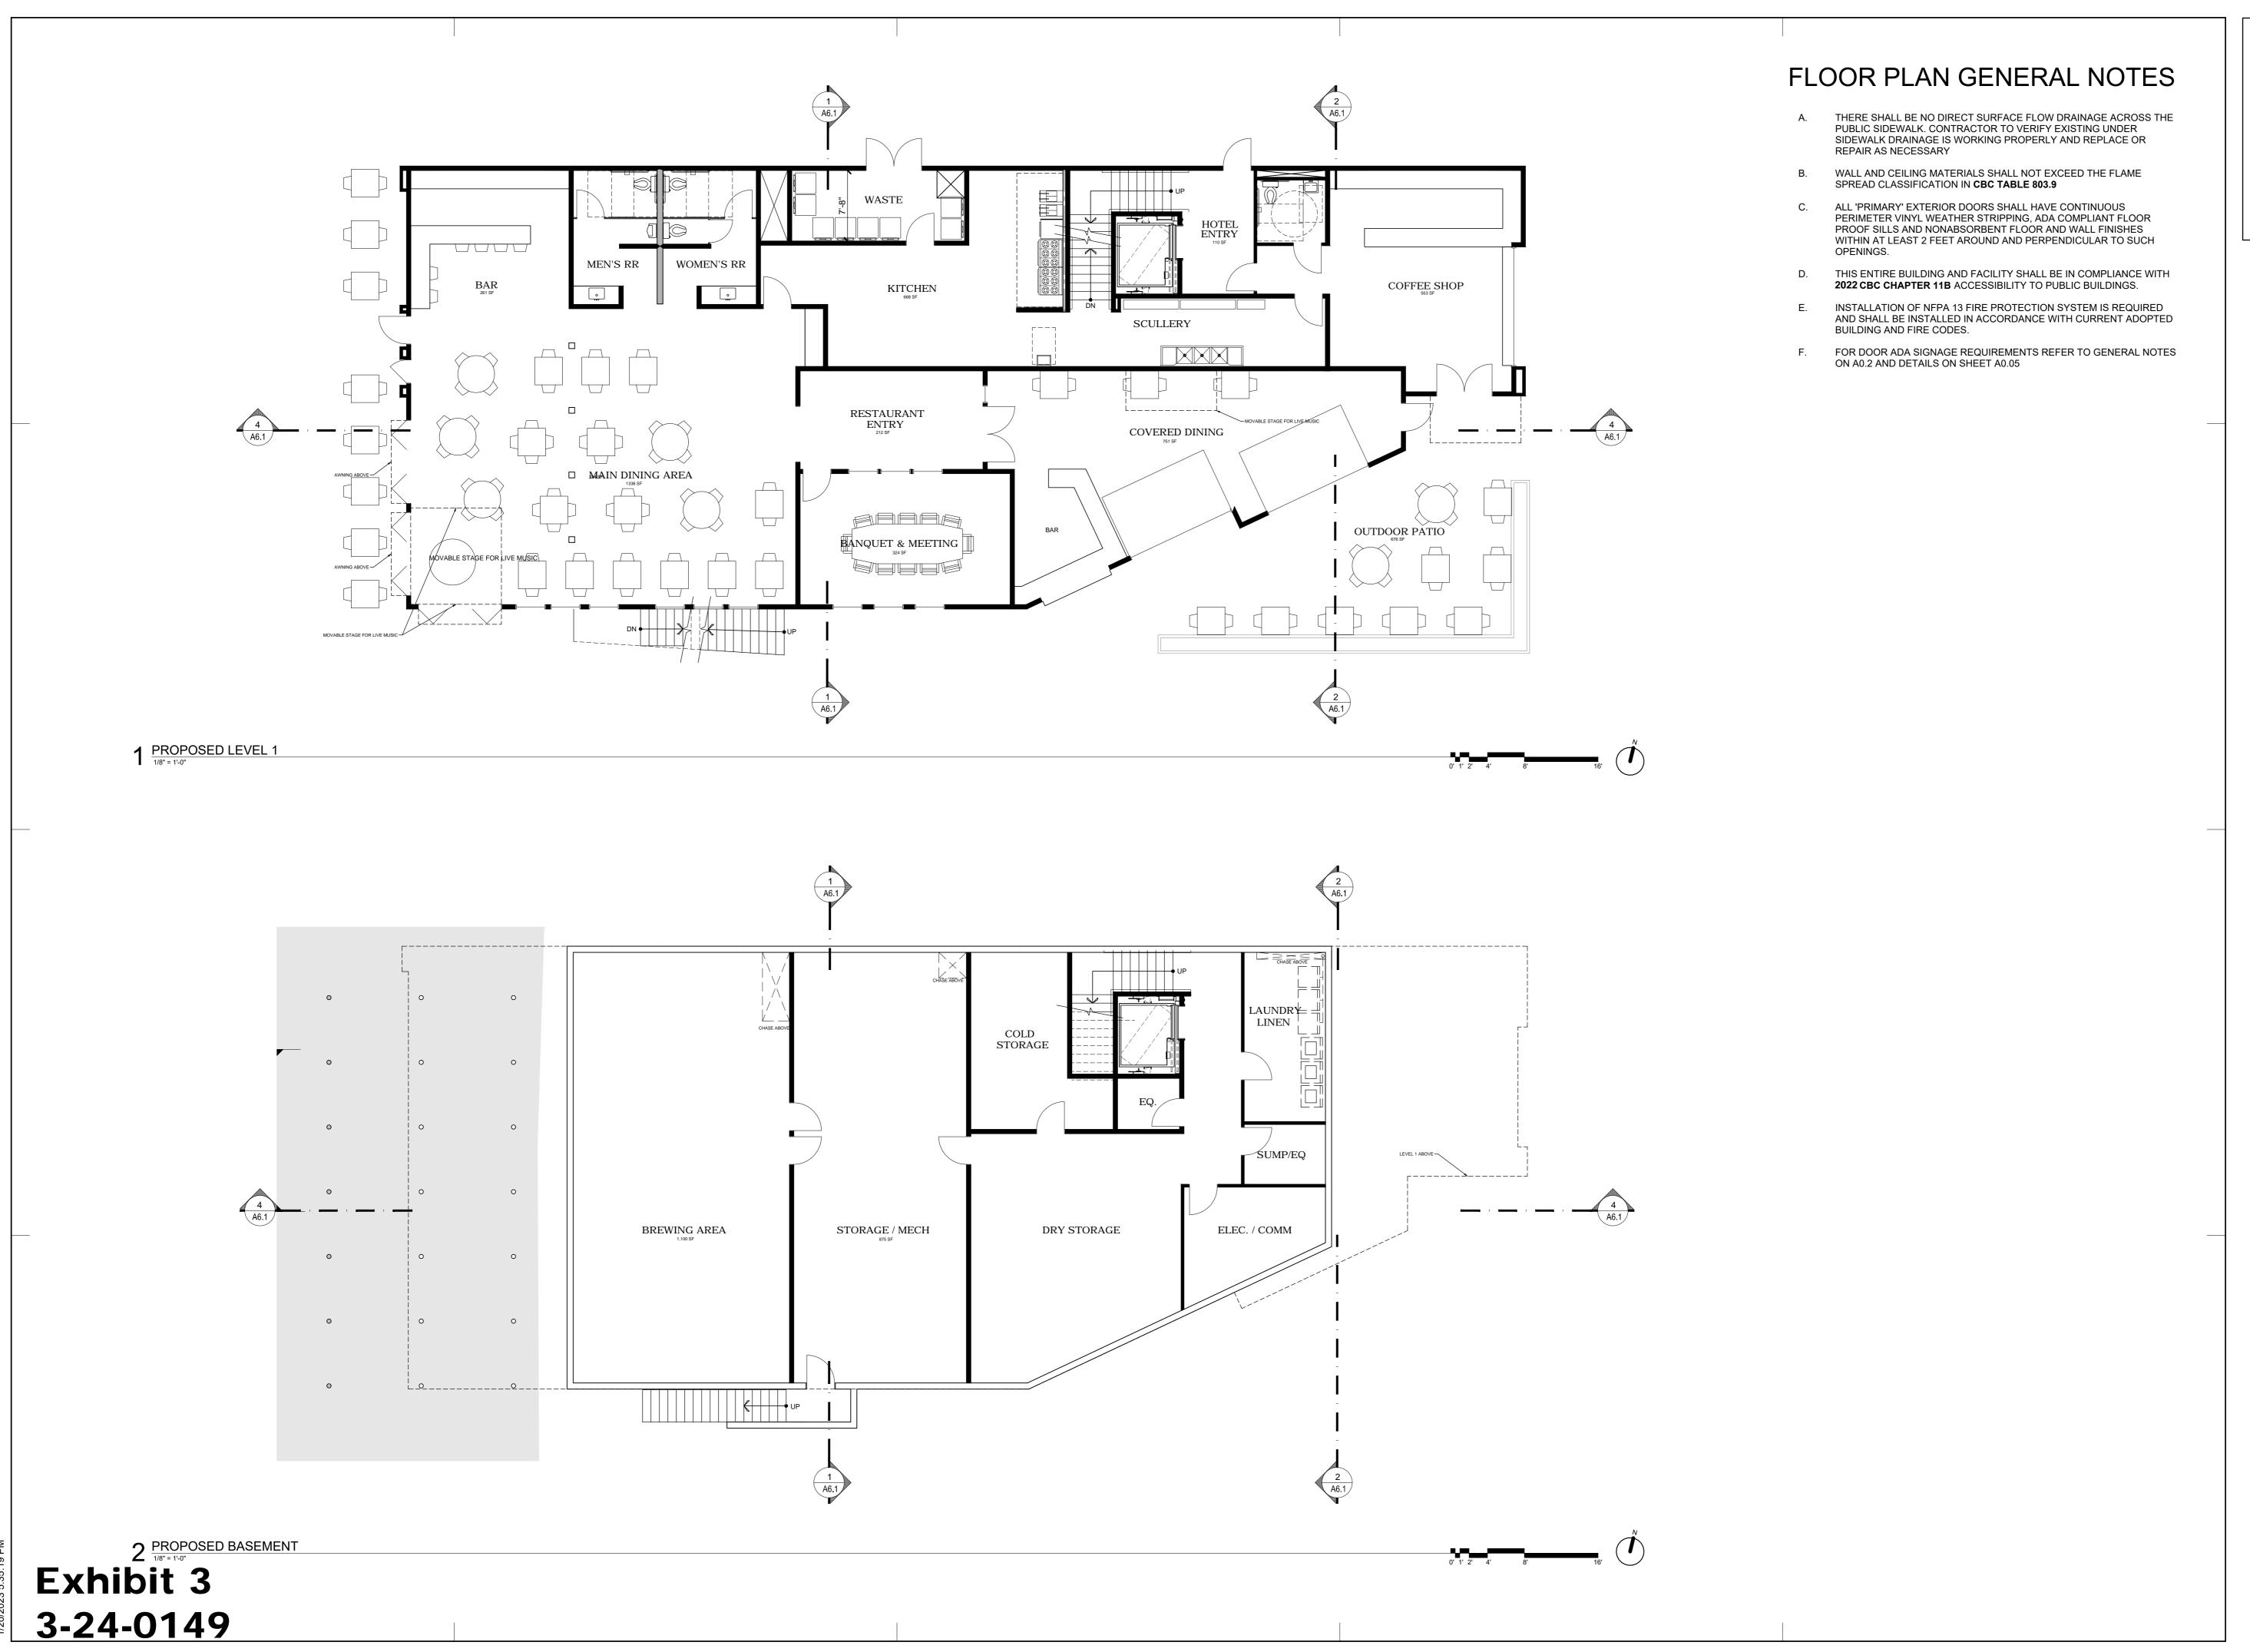

MORRO BAY STAMP AREA

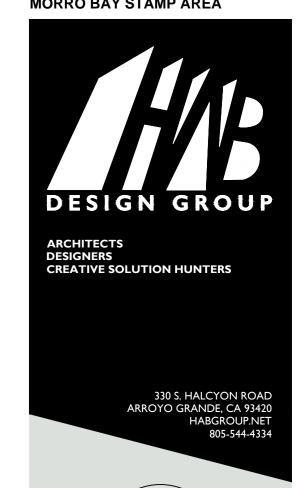

ARCHITECT OF RECORD


ANS

SHEET THESE DRAWINGS ARE INSTRUMENTS OF SERVICE AND ARE THE PROPERTY OF OUTLIER/TREVOR MILLER ARCHITECT (OTLR), ALL COMMON COPYRIGHT AND OTHER PROPERTY RIGHTS RESERVED. THIS DOCUMENT SHALL NOT BE DUPLICATED, COPIED, DISCLOSED, OR USED IN CONNECTION WITH ANY WORK OR PROJECT OTHER THAN THE SPECIFIC PROJECT FOR WHICH IT HAS BEEN PREPARED, OR ASSIGNED TO ANY THIRD PARTY WITHOUT FIRST OBTAINING THE EXPRESS WRITTEN CONSENT OF OTLR. VISUAL CONTACT WITH THIS DOCUMENT SHALL CONSTITUTE CONCLUSIVE EVIDENCE OF ACCEPTANCE OF THESE RESTRICTIONS.

REVISION HISTORY

APP# APN# 006-322-008 JOB# 20-185 DATE 2023-11-01 TW CHECKED

SHEET NUMBER

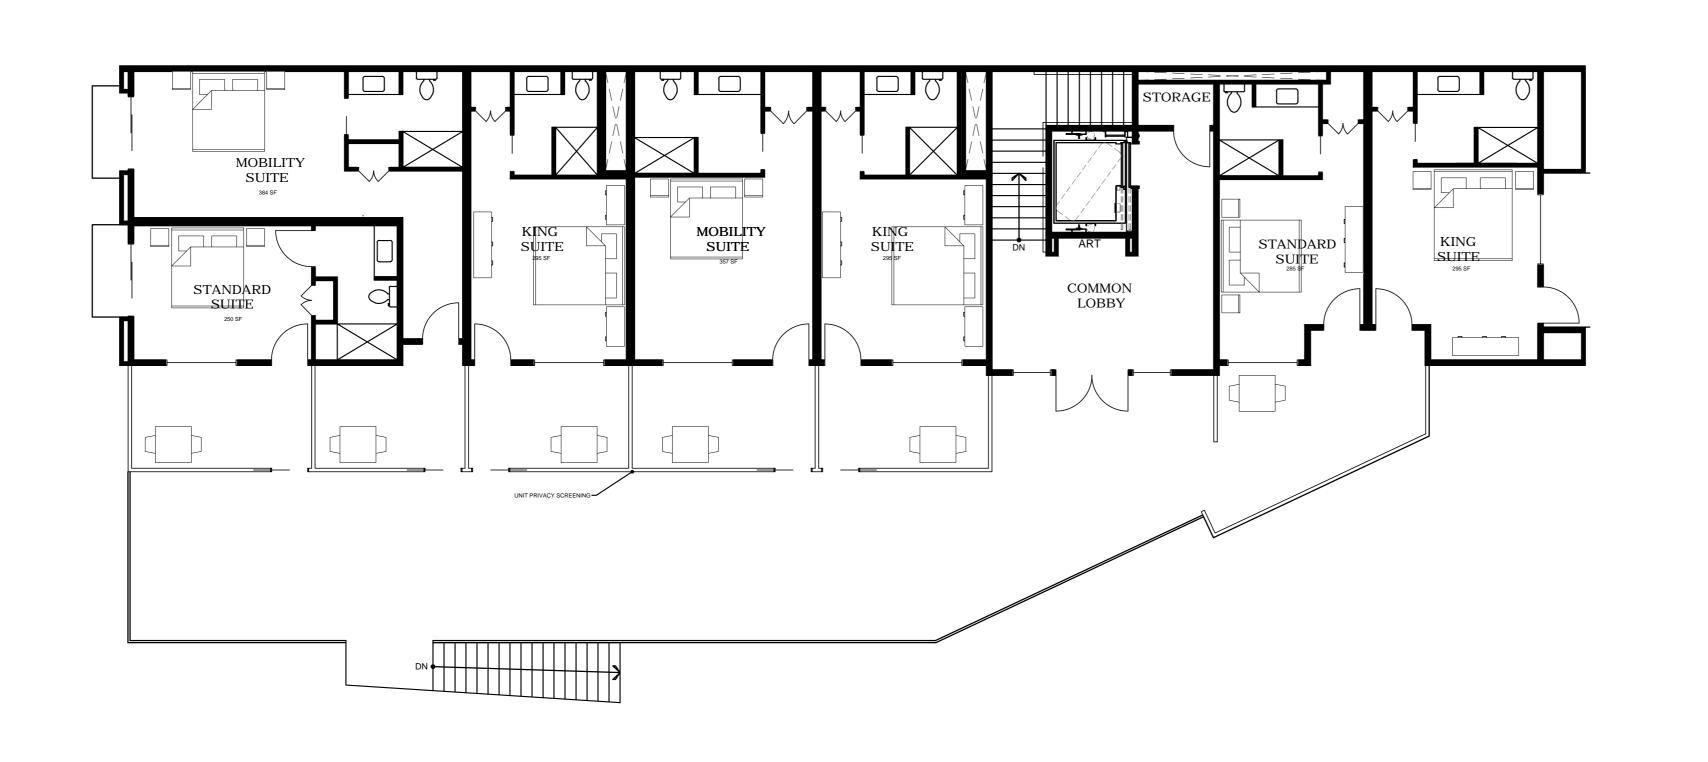


- PROVIDE ADEQUATE ROOF SLOPE FOR DRAINAGE (1/4" PER FOOT, MIN.) OR SUBMIT DEFLECTION AND PONDING CALCULATIONS.
- RADIANT BARRIER TO BE INSTALLED IN ACCORDANCE WITH THE T24

FLOOR PLAN GENERAL NOTES

- THERE SHALL BE NO DIRECT SURFACE FLOW DRAINAGE ACROSS THE PUBLIC SIDEWALK. CONTRACTOR TO VERIFY EXISTING UNDER SIDEWALK DRAINAGE IS WORKING PROPERLY AND REPLACE OR REPAIR AS NECESSARY
- WALL AND CEILING MATERIALS SHALL NOT EXCEED THE FLAME SPREAD CLASSIFICATION IN CBC TABLE 803.9
- C. ALL 'PRIMARY' EXTERIOR DOORS SHALL HAVE CONTINUOUS PERIMETER VINYL WEATHER STRIPPING, ADA COMPLIANT FLOOR PROOF SILLS AND NONABSORBENT FLOOR AND WALL FINISHES WITHIN AT LEAST 2 FEET AROUND AND PERPENDICULAR TO SUCH
- THIS ENTIRE BUILDING AND FACILITY SHALL BE IN COMPLIANCE WITH 2019 CBC CHAPTER 11B ACCESSIBILITY TO PUBLIC BUILDINGS.
- INSTALLATION OF NFPA 13 FIRE PROTECTION SYSTEM IS REQUIRED AND SHALL BE INSTALLED IN ACCORDANCE WITH CURRENT ADOPTED BUILDING AND FIRE CODES.
- FOR DOOR ADA SIGNAGE REQUIREMENTS REFER TO GENERAL NOTES ON A0.2 AND DETAILS ON SHEET A0.03

ROOF GENERAL NOTES

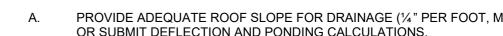

MORRO BAY STAMP AREA






THESE DRAWINGS ARE INSTRUMENTS OF SERVICE AND ARE THE PROPERTY OF OUTLIER/TREVOR MILLER ARCHITECT (OTLR), ALL COMMON COPYRIGHT AND OTHER PROPERTY RIGHTS RESERVED. THIS DOCUMENT SHALL NOT BE DUPLICATED, COPIED, DISCLOSED, OR USED IN CONNECTION WITH ANY WORK OR PROJECT OTHER THAN THE SPECIFIC PROJECT FOR WHICH IT HAS BEEN PREPARED, OR ASSIGNED TO ANY THIRD PARTY WITHOUT FIRST OBTAINING THE EXPRESS WRITTEN CONSENT OF OTLR. VISUAL CONTACT WITH THIS DOCUMENT SHALL CONSTITUTE CONCLUSIVE EVIDENCE OF ACCEPTANCE OF THESE RESTRICTIONS.

REV	REVISION HISTORY							
NO.	DESC.	DATE						

APP#			
APN#		006-32	2-008
JOB#		2	0-185
DATE		2023-	11-01
DRAWN BY:	TW	CHECKED BY:	TM

SHEET NUMBER

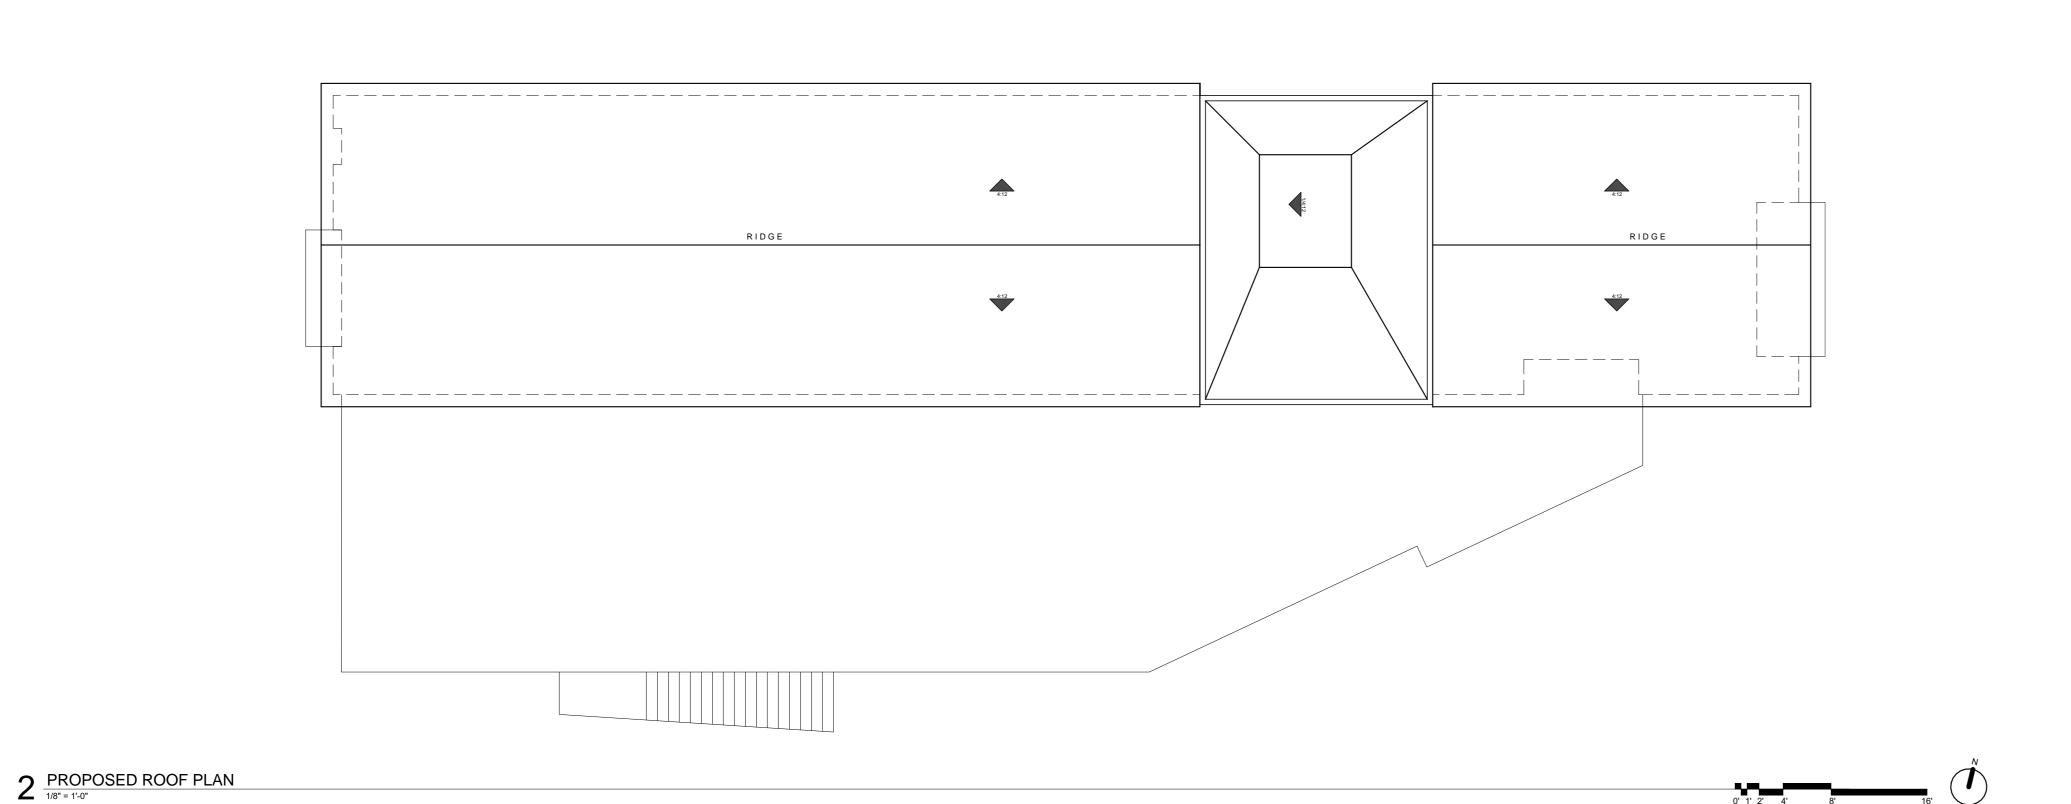

1 PROPOSED LEVEL 2


1/8" = 1'-0"




Page 12 of 18



Page 13 of 18

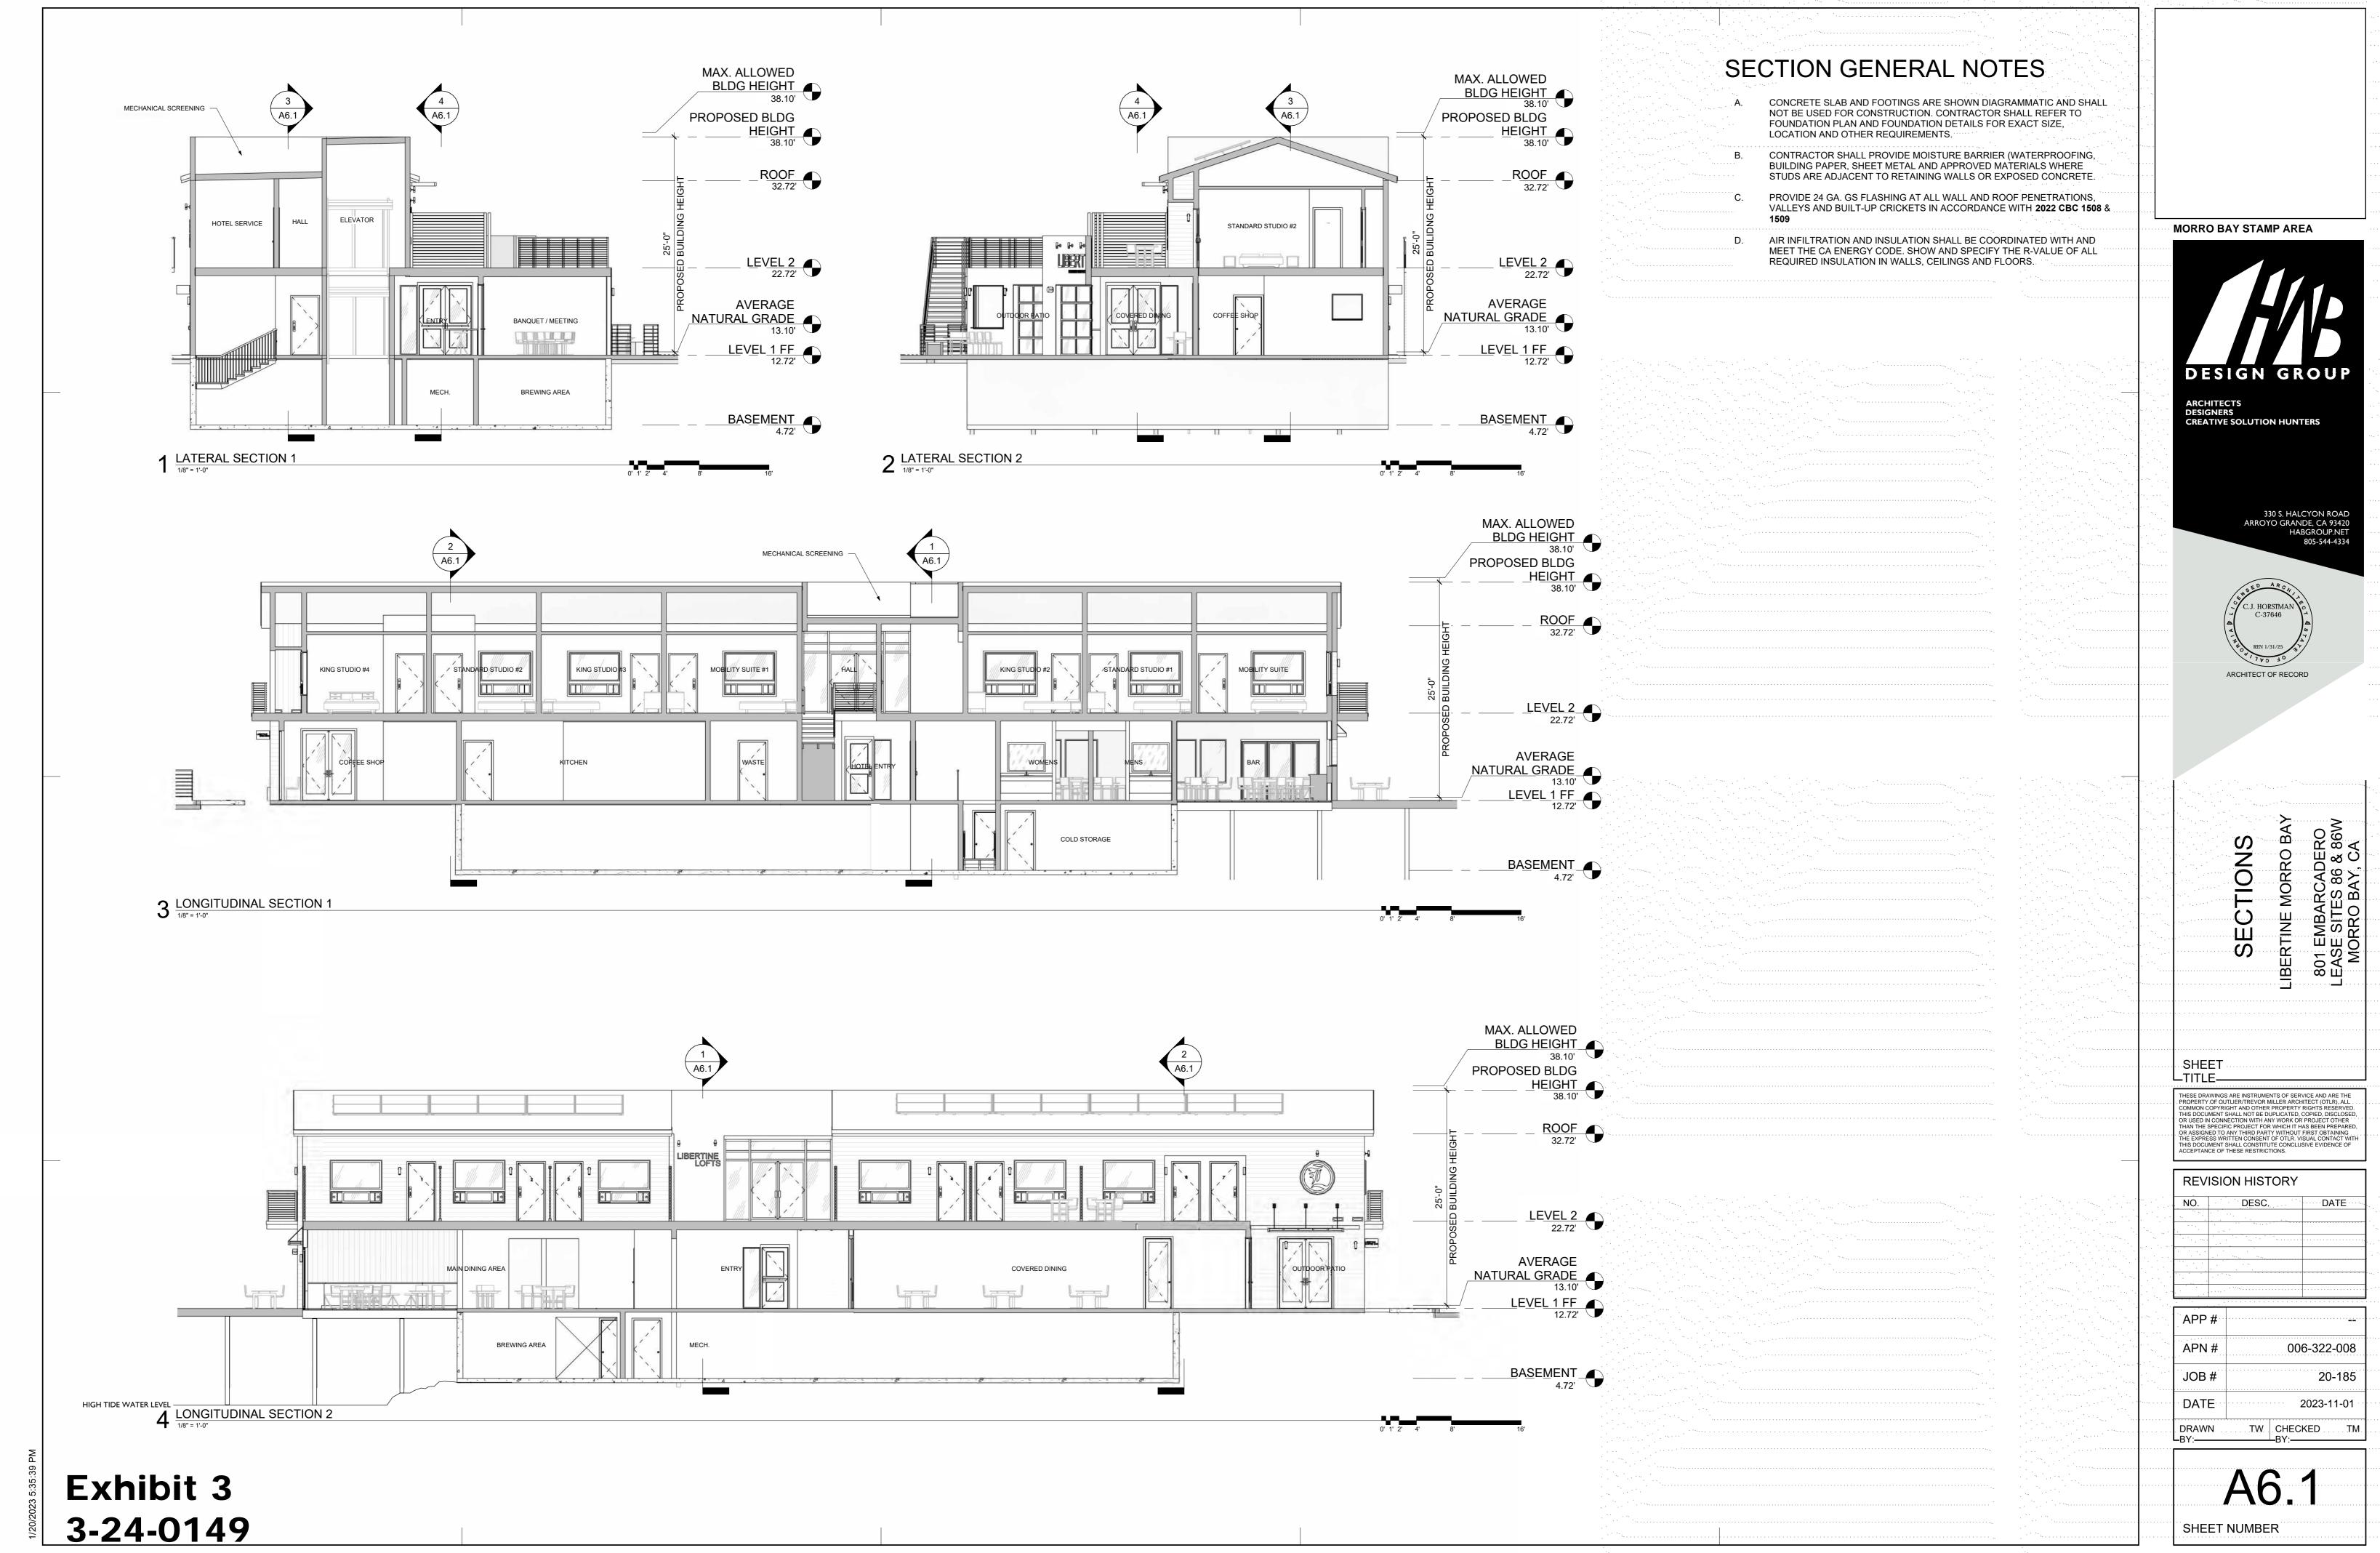

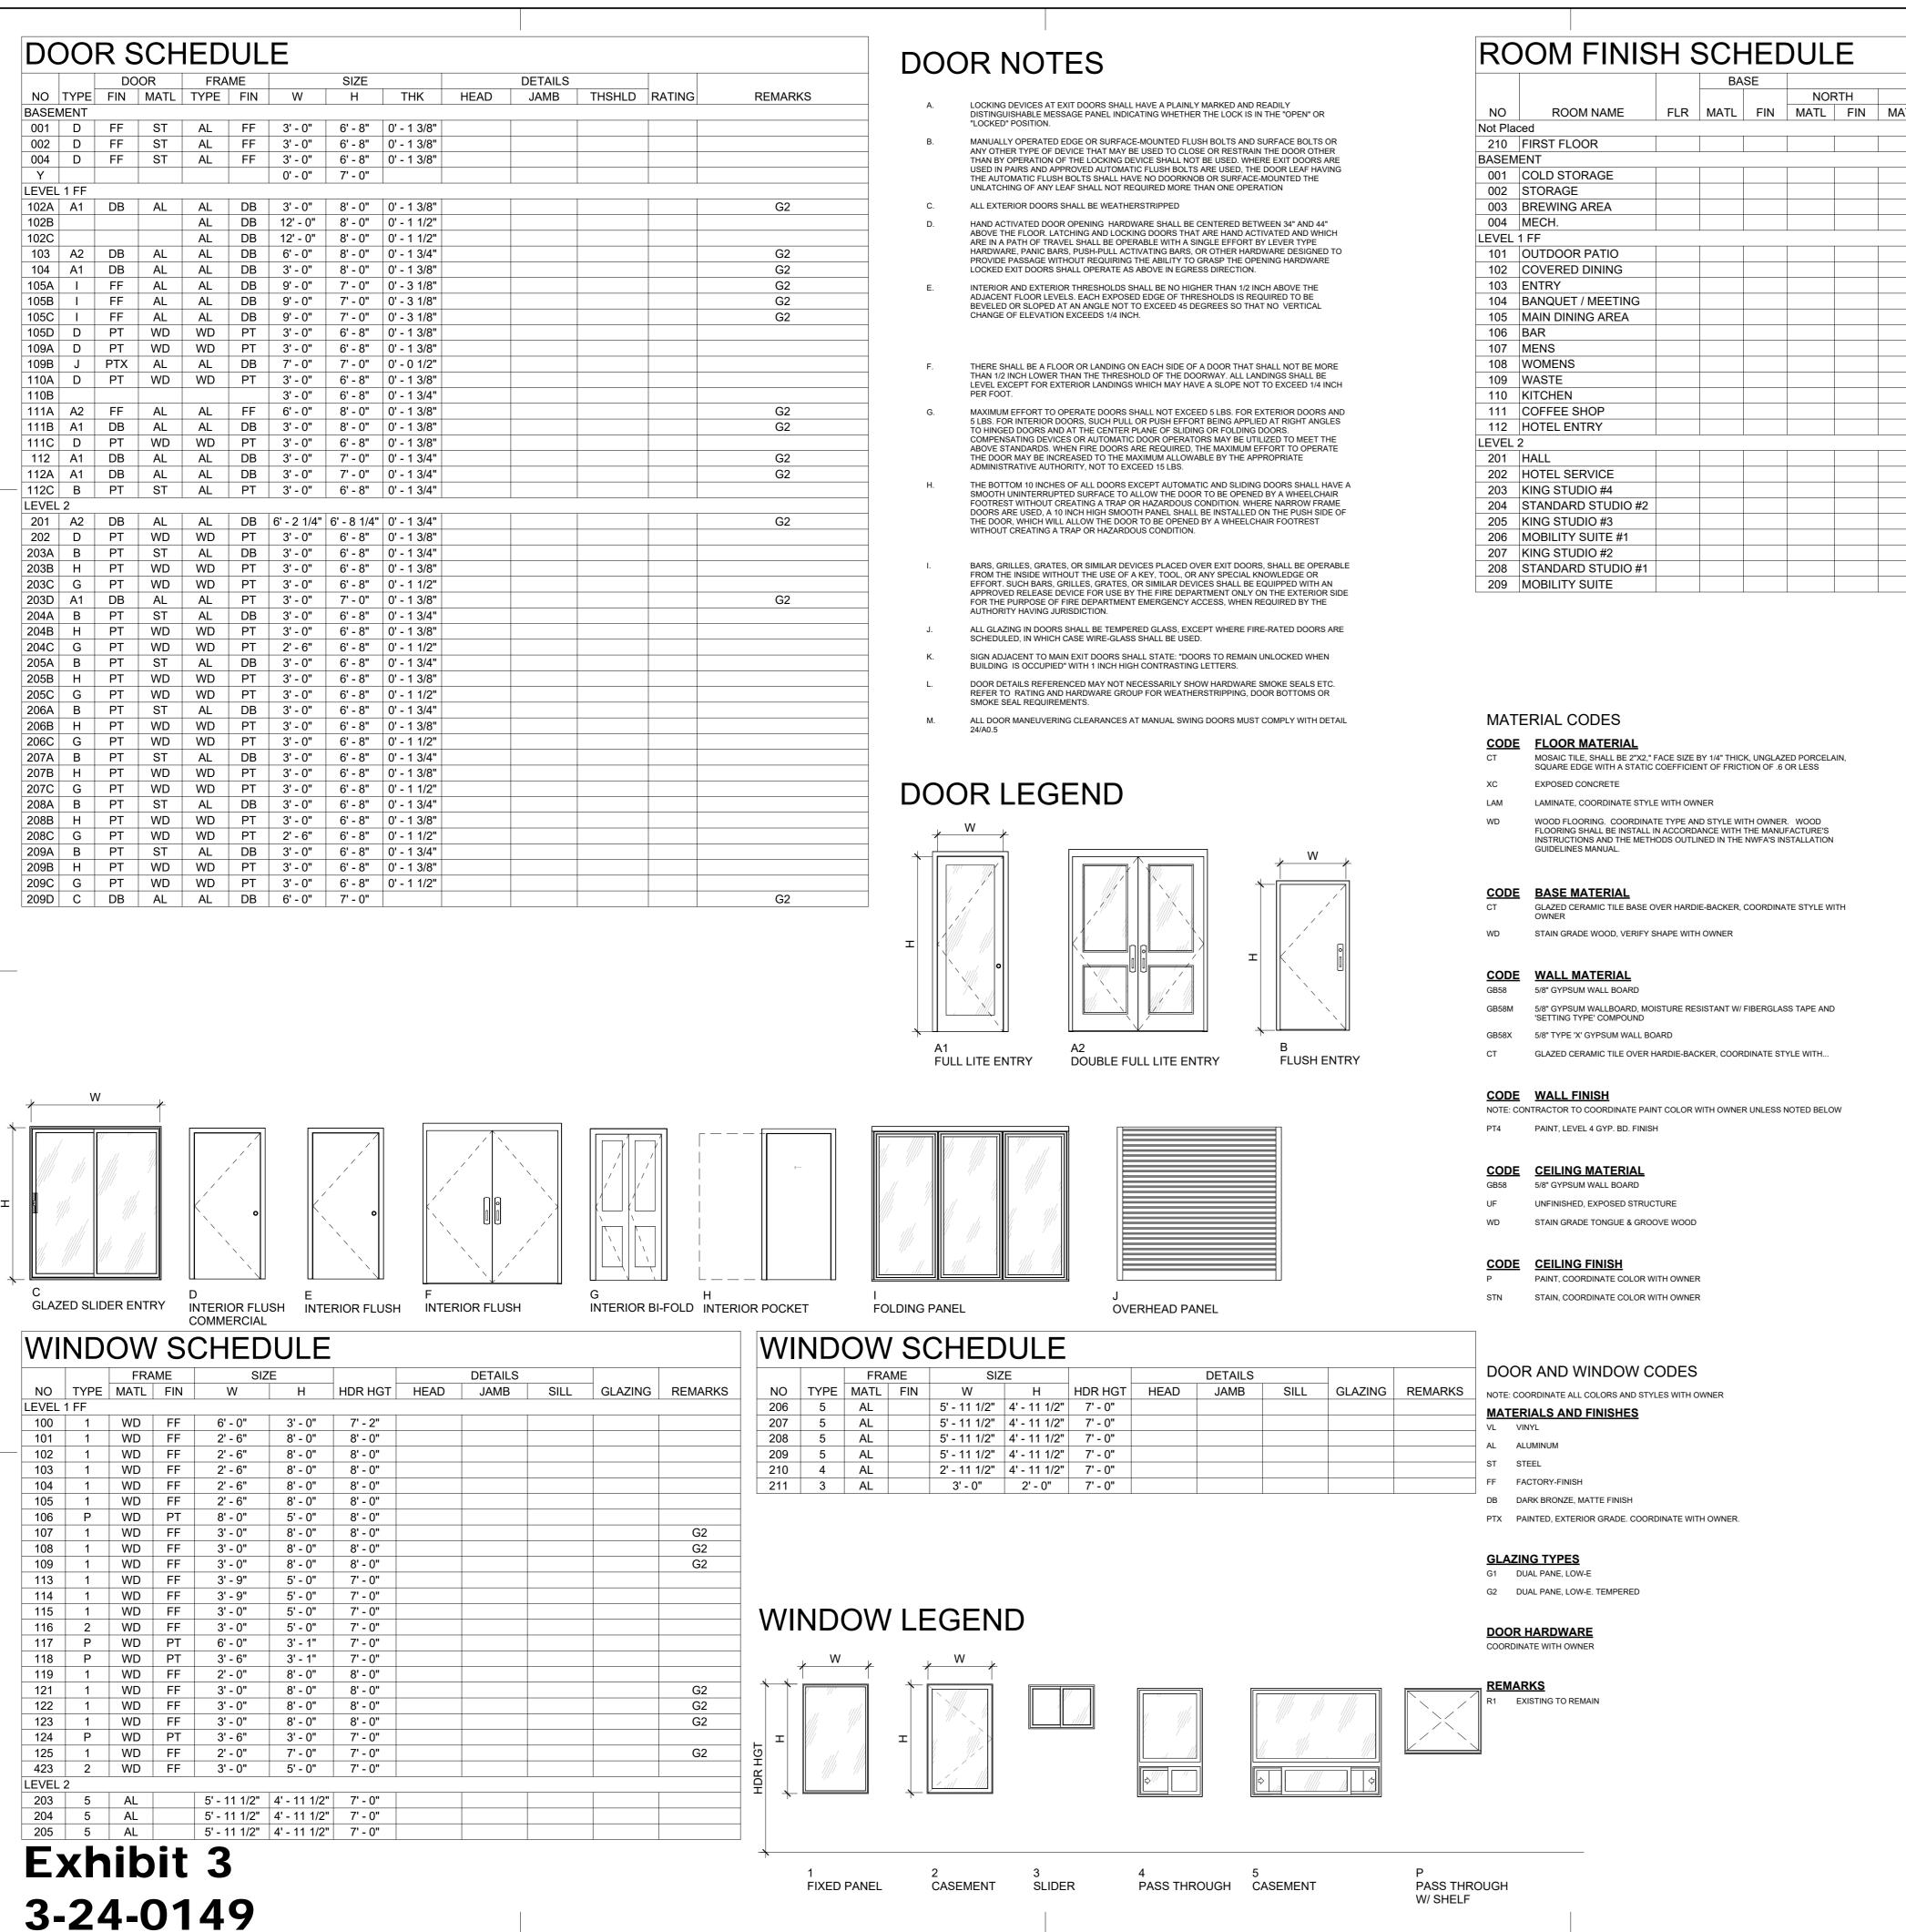


			BASE					WALLS CEILING WAINSCOT				WALLS			CEILING WAINSCOT				
					NORTH	EA	ST	SOL	JTH	WE	ST								
NO	ROOM NAME	FLR	MATL F	IN MA	TL FIN	MATL	FIN	MATL	FIN	MATL	FIN	HGT	FIN	MATL	WALL	MATL	FIN	HGT	REMARKS
Not Pla	iced					•													
210	FIRST FLOOR											8' - 0"							
BASEN	MENT																		
001	COLD STORAGE											7' - 4 3/4"							
002	STORAGE											8' - 0"							
003	BREWING AREA											8' - 0"							
004	MECH.											8' - 0"							
EVEL	1 FF							•											
101	OUTDOOR PATIO											10' - 0"							
102	COVERED DINING											9' - 0"							
103	ENTRY											9' - 0"							
104	BANQUET / MEETING											9' - 0"							
105	MAIN DINING AREA											9' - 0"							
106	BAR											9' - 0"							
107	MENS											9' - 0"							
108	WOMENS											9' - 0"							
109	WASTE											9' - 0"							
110	KITCHEN											9' - 0"							
111	COFFEE SHOP											9' - 0"							
112	HOTEL ENTRY											8' - 0"							
LEVEL	2			'	'	'									'	'		'	
201	HALL											10' - 0"							
202	HOTEL SERVICE											10' - 0"							
203	KING STUDIO #4											10' - 0"							
204	STANDARD STUDIO #2											10' - 0"							
205	KING STUDIO #3											10' - 0"							
206	MOBILITY SUITE #1											10' - 0"							
	KING STUDIO #2											10' - 0"							
	STANDARD STUDIO #1											10' - 0"							
	MOBILITY SUITE											10' - 0"							

REFER TO NOTES ON SHEET A0.3 AND A0.5 MANUF. MODEL LEVEL 1 FF COFFEE SHOP 16" Watercloset TBD Accessible Sink, Faucet, and Counter Accessible Grab Bars MENS 16" Watercloset TBD TBD Accessible Sink, Faucet, and Counter TOTO UT447 WOMENS 16" Watercloset TBD TBD TBD 16" Watercloset Accessible Sink, Faucet, and Counter LEVEL 2 KING STUDIO #2 16" Watercloset TBD TBD Sink basin and Faucet 60" Bathtub with Fixtures KING STUDIO #3 16" Watercloset TBD TBD Sink basin and Faucet 60" Bathtub with Fixtures KING STUDIO #4 16" Watercloset TBD TBD Sink basin and Faucet 60" Bathtub with Fixtures MOBILITY SUITE TBD TBD 16" Watercloset Sink basin and Faucet Roll-In Tub with Accessible Fixtures MOBILITY SUITE #1 16" Watercloset TBD TBD Sink basin and Faucet Roll-In Tub with Accessible Fixtures STANDARD STUDIO #1 TBD 16" Watercloset TBD Sink basin and Faucet 60" Bathtub with Fixtures STANDARD STUDIO #2 TBD 16" Watercloset TBD Sink basin and Faucet 60" Bathtub with Fixtures

PLUMBING FIXTURE...

PLUMBING FIXTURES TO MEET CALGREEN MANDATORY MEASURES

MORRO BAY STAMP AREA

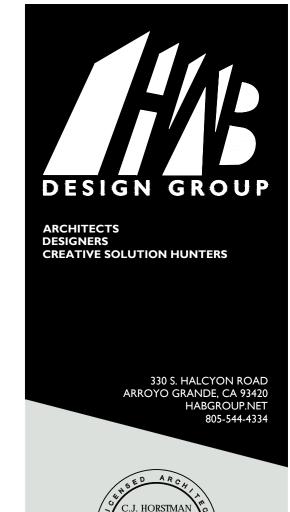

C-37646

ARCHITECT OF RECORD

DULE 801 EMBARCADEF LEASE SITES 86 & 8 MORRO BAY, CA SCHE

LTITLE_ THESE DRAWINGS ARE INSTRUMENTS OF SERVICE AND ARE THE COMMON COPYRIGHT AND OTHER PROPERTY RIGHTS RESERVED THIS DOCUMENT SHALL NOT BE DUPLICATED, COPIED, DISCLOSE OR USED IN CONNECTION WITH ANY WORK OR PROJECT OTHER THAN THE SPECIFIC PROJECT FOR WHICH IT HAS BEEN PREPARE OR ASSIGNED TO ANY THIRD PARTY WITHOUT FIRST OBTAINING THE EXPRESS WRITTEN CONSENT OF OTLR. VISUAL CONTACT WITHIS DOCUMENT SHALL CONSTITUTE CONCLUSIVE EVIDENCE OF ACCEPTANCE OF THESE RESTRICTIONS.

SHEET

REVISION HISTORY DATE DESC.

APP# APN# 006-322-008 JOB# 20-185 DATE 2023-11-01 TW CHECKED TM DRAWN

SHEET NUMBER



WALL SIGN (LETTERS MAIN)


3/4" = 1'-0"

 * SIGN TO BE METAL EXTERIOR ILLUMINATED. ATTACH PER MANUFACTUR SPECIFICATIONS.



2 WALL SIGN (LOGO SOUTH) 3 WALL SIGN (LOGO EAST) * SIGN TO BE METAL EXTERIOR ILLUMINATED. ATTACH PER MANUFACTUR SPECIFICATIONS. * PRIMARY FACADE SIGN * SIGN TO BE METAL EXTERIOR ILLUMINATED. ATTACH PER MANUFACTUR SPECIFICATIONS.

9 5 PUB SIGN (LOFTS)

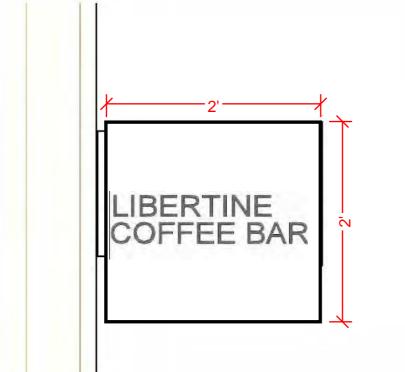



PUB SIGN (COFFEE)

1 1/2" = 1'-0"

* SIGN TO BE METAL. ATTACH PER MANUFACTUR SPECIFICATIONS.

LIBERTINE LOFTS

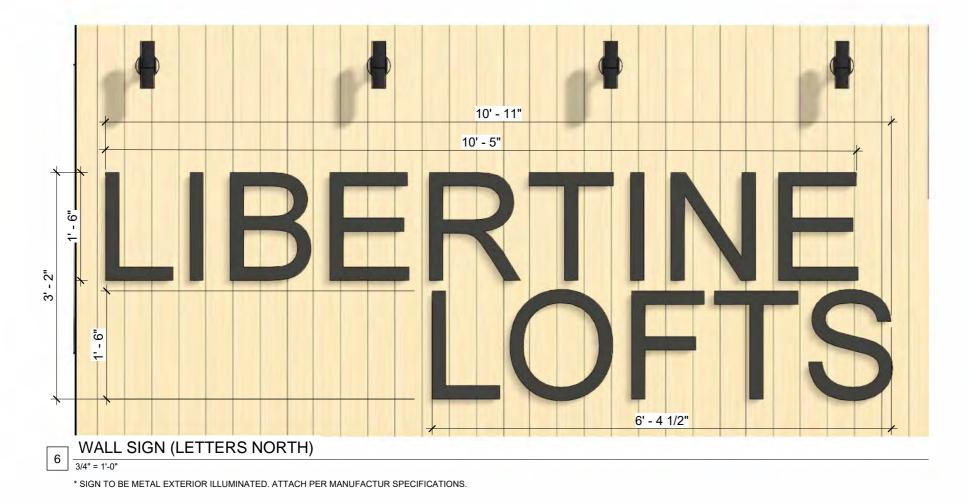

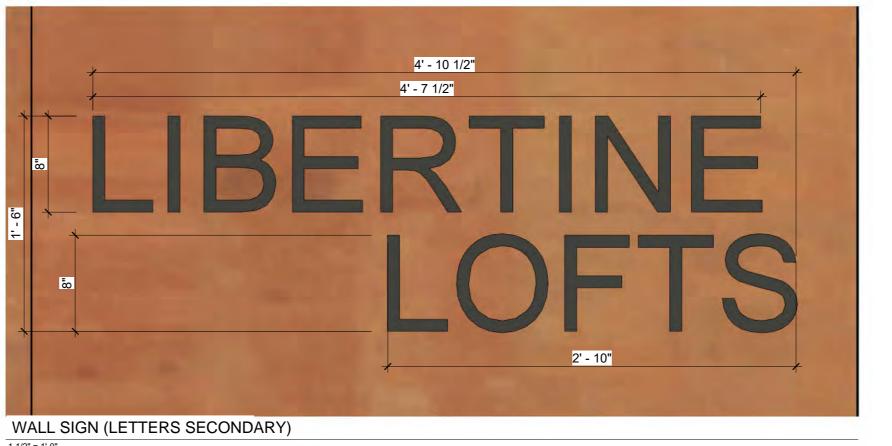

* SIGN TO BE METAL. ATTACH PER MANUFACTUR SPECIFICATIONS.

Exhibit 3 3-24-0149 7 WALL SIGN (LETTERS SECONDARY)

* SIGN TO BE METAL. ATTACH PER MANUFACTUR SPECIFICATIONS.

SIGNAGE CALCULATIONS East Elevation: 3 WALL SIGN (LOGO EAST) 4' DIA 4 PUB SIGN (COFFEE) 2'x2' 4 SF 4 SF 2'x2' 5 PUB SIGN (LOFTS) 24 SF South Elevation: 1 WALL SIGN (LETTERS MAIN) 15'-5" x 2'-2" 4' DIA 2 WALL SIGN (LOGO SOUTH) 16 SF 7 WALL SIGN (LETTERS SECONDARY) 4'-10.5" x 1'-6 7.31 SF 45.88 SF West Elevation: NO SIGNAGE PROPOSED 0 SF North Elevation: 6 WALL SIGN (LETTERS NORTH) 34.57 SF 10'-11" x 3'-2 8 WALL SIGN (LETTERS LOFTS) 2'-5" x 0'-9" 1.81 SF 36.38 SF 106.26 Total Proposed All Elevations

8 WALL SIGN (LETTERS LOFTS)

* SIGN TO BE METAL. ATTACH PER MANUFACTUR SPECIFICATIONS

MORRO BAY STAMP AREA ARCHITECTS
DESIGNERS
CREATIVE SOLUTION HUNTERS Primary Façade Area (east elevation) = 317 sf proposed Secondary Façade Area (other elevations) = 86.83 sf proposed.

SIGNAGE

ARCHITECT OF RECORD

330 S. HALCYON ROAD ARROYO GRANDE, CA 93420

THESE DRAWINGS ARE INSTRUMENTS OF SERVICE AND ARE THE PROPERTY OF OUTLIER/TREVOR MILLER ARCHITECT (OTLR), ALL COMMON COPYRIGHT AND OTHER PROPERTY RIGHTS RESERVED. THIS DOCUMENT SHALL NOT BE DUPLICATED, COPIED, DISCLOSED OR USED IN CONNECTION WITH ANY WORK OR PROJECT OTHER THAN THE SPECIFIC PROJECT FOR WHICH IT HAS BEEN PREPARED OR ASSIGNED TO ANY THIRD PARTY WITHOUT FIRST ORTAINING OR ASSIGNED TO ANY THIRD PARTY WITHOUT FIRST OBTAINING. THE EXPRESS WRITTEN CONSENT OF OTLR. VISUAL CONTACT WIT THIS DOCUMENT SHALL CONSTITUTE CONCLUSIVE EVIDENCE OF ACCEPTANCE OF THESE RESTRICTIONS.


REVISION HISTORY

APP# 006-322-008 APN# JOB# 20-185 DATE 2023-11-01 T.W. CHECKED T.M

SHEET NUMBER






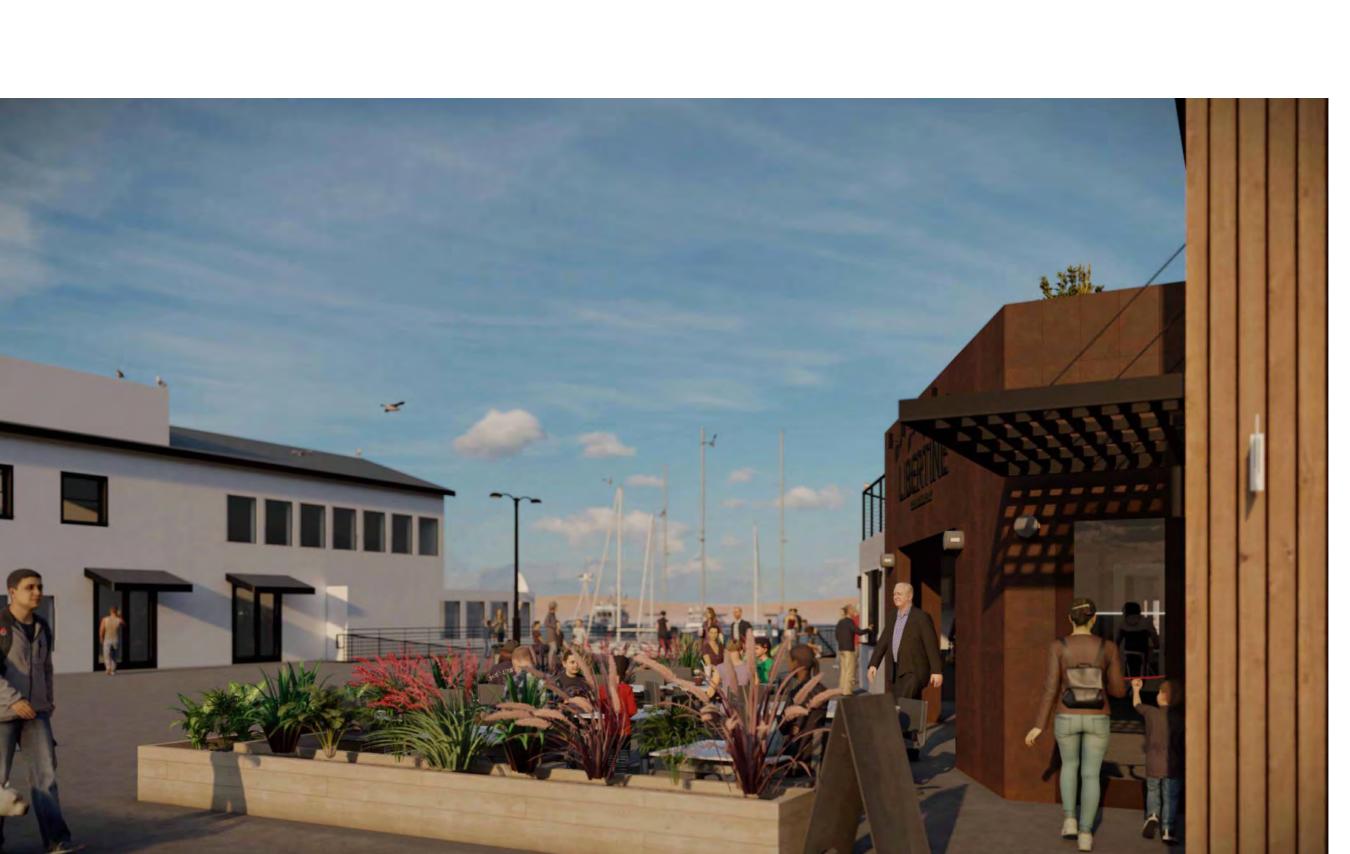



MORRO BAY STAMP AREA

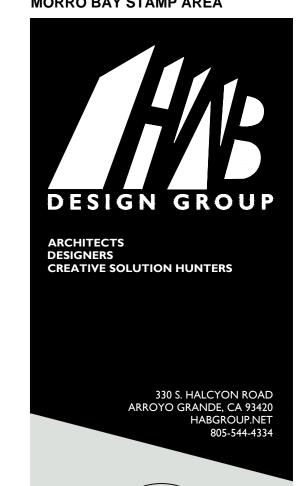



THESE DRAWINGS ARE INSTRUMENTS OF SERVICE AND ARE THE PROPERTY OF OUTLIER/TREVOR MILLER ARCHITECT (OTLR), ALL COMMON COPYRIGHT AND OTHER PROPERTY RIGHTS RESERVED. THIS DOCUMENT SHALL NOT BE DUPLICATED, COPIED, DISCLOSED, OR USED IN CONNECTION WITH ANY WORK OR PROJECT OTHER THAN THE SPECIFIC PROJECT FOR WHICH IT HAS BEEN PREPARED, OR ASSIGNED TO ANY THIRD PARTY WITHOUT FIRST OBTAINING THE EXPRESS WRITTEN CONSENT OF OTLR. VISUAL CONTACT WITH THIS DOCUMENT SHALL CONSTITUTE CONCLUSIVE EVIDENCE OF ACCEPTANCE OF THESE RESTRICTIONS.

REVISION HISTORY

APP # 			
APN#		006-32	2-008
JOB#		2	0-185
DATE		2023-	11-01
DRAWN	TW	CHECKED	TM

SHEET NUMBER

Exhibit 3 3-24-0149

MORRO BAY STAMP AREA

ARCHITECTS
DESIGNERS
CREATIVE SOLUTION HUNTERS











Exhibit 3 3-24-0149

Page 18 of 18

REVISION HISTORY

APP#			
APN#		006-32	2-008
JOB#		20	0-185
DATE		2023-	11-01
DRAWN	TW	CHECKED	TM

SHEET NUMBER

RESOLUTION NO. 08-24

RESOLUTION OF THE CITY COUNCIL
OF THE CITY OF MORRO BAY, CALIFORNIA
APPROVING COMBINED CONCEPT/PRECISE PLAN CONDITIONAL
USE PERMIT APPROVAL (#CUP22-09) FOR DEMOLITION AND
RECONSTRUCTION OF TWO-STORY WITH BASEMENT MIXED-USE
BUILDING INCLUDING RESTAURANT, COFFEE SHOP, BREWING AREA, 7
UNIT HOTEL, OUTDOOR DINING, RECONSTRUCTION OF NEW SIDE-TIE
DOCK AND GANGWAY, MASTER SIGN PROGRAM APPROVAL,
HARBORWALK AND PUBLIC ACCESS IMPROVEMENTS, INCLUDING
REMOVAL OF 11 PUBLIC PARKING SPACES IN STREET-END FOR
CREATION OF NEW PUBLIC PLAZA,
AT 801 EMBARCADERO, LIBERTINE BREWING
(CITY LEASE SITE 86 AND 86W).

THE CITY COUNCIL City of Morro Bay, California

WHEREAS, the Planning Commission of the City of Morro Bay conducted a public hearing at the Morro Bay Veteran's Hall, 209 Surf Street, Morro Bay, California, on December 19, 2023, for the purpose of considering a combined Concept/Precise Plan approval of Conditional Use Permit #CUP22-09 ("the Project"); and

WHEREAS, the City's City Council conducted a public hearing at the Morro Bay Veteran's Hall, 209 Surf Street, Morro Bay, California, on January 23, 2024, pursuant to the Planned Development regulations (Morro Bay Municipal Code (MBMC) section 17.40.030), for the purpose of considering the Project for 801 Embarcadero, also known as the Libertine Brewing Company, in an area within the original jurisdiction of the California Coastal Commission; and

WHEREAS, notices of the public hearings were made at the time and in the manner required by law; and

WHEREAS, the City Council has duly considered all evidence, including the testimony of the Applicant, interested parties, and the evaluation and recommendations by staff, presented at said hearing.

NOW, THEREFORE, BE IT RESOLVED by the City Council of the City of Morro Bay as follows:

Section 1: Findings. Based upon all the evidence, the Council makes the following findings:

California Environmental Quality Act (CEQA)

A. That for purposes of the California Environmental Quality Act, Case No. CUP22-09 is categorically exempt under Section 15302, Class 2b where under replacement of reconstruction of commercial structure with a new structure of substantially the same, size, purpose, and capacity is allowed for which the proposed Harborwalk Plaza project would quality for an exemption. In addition, an eelgrass survey was performed on October 16, 2022 which found no eelgrass growing in the proposed waterfront project area. The project will be subject to marine mammal monitoring during construction with implementation of best management practices (BMPs) as conditioned by Planning conditions 10-15. Additionally,

none of the Categorical Exemption exceptions, noted under section 15300.2, apply to the project.

CONDITIONAL USE PERMIT FINDINGS

- A. The project will not be detrimental to the health, safety, morals, comfort and general welfare of the persons residing or working in the neighborhood in that demolition/reconstruction of mixed use two story building of 7 hotel units and ground floor restaurant and coffee shop uses with reconstructed dock system at 801 Embarcadero are permitted uses within the zoning district and said structures comply with all applicable project conditions and City regulations and is consistent with the City's Local Coastal Program.
- B. The project will not be injurious or detrimental to property and improvements in the neighborhood and the general welfare of the City in that the proposed hotel use, new restaurant, coffee shop, outdoor dining, reconstructed side-tie dock and gangway along with public plaza will provide a visitor-serving recreational opportunity which will provide additional benefit and improvement to a visitor-serving commercial use and is consistent with the character of the existing development.

Waterfront Master Plan Findings

- A. The proposed project makes a positive contribution to the visual and public accessibility to the bay while increasing and maintaining commercial fishing industry:
 - Meets the Waterfront plan height limit and maximum building coverage, bulk, and scale requirements in that the proposed project does not exceed the maximum height allowed and interesting articulation breaks up the bulk and scale, and complies with roof sloping requirements.
 - 2. In the case of granting height greater than 17 feet, the proposed project also provides significant public benefit pursuant to the Planned Development Overlay zone requirements in that the proposed project is providing significant public benefit in the form of a 15 foot wide Harborwalk where 10 foot is the requirement, a second floor public viewing deck, publicly accessible dock, and creation of public plaza improvements and event space.
 - 3. The proposed project provides the amenities identified in the WF Plan, facilitates pedestrian visual and physical access to the waterfront, and takes advantage of outward views and characteristics of the topography in that the buildingincluding a 2nd level open public viewing deck, adding new public coastal access signage, improved overall commercial signage aesthetics through the sign program proposed for the new building, provides overnight accommodations, and preserves scenic vistas at the street ends which enhances public amenities in this areas with the creation of the public plaza. The open second floor public viewing deck enhances the views as seen from the bluff top looking across the building towards the bay.
 - 4. The proposed project makes a positive contribution to the working fishing village character and quality of the Embarcadero area in that the new project will add to the pedestrian orientation with outdoor dining area, public plaza improvements, which will maintain and enhance views of the bay.

- 5. The proposed project recognizes the pedestrian orientation of the Embarcadero and provides an interesting and varied design that will enhance the pedestrian experience in that the new building will open up to the passing pedestrian through creation of 15 foot Harborwalk/bayside lateral access where none currently exists.
- The project gives its occupants and the public some variety in materials and/or application in that the building will consist of composite wood and shiplap siding, corten panels and standing seam metal roof and the outdoor dining area will be bordered by drought tolerant landscaping in an attractive planter area.
- 7. The project contains the elements of harmony, continuity, proportion, simplicity, and balance, and its appearance matches its function and the uses proposed in that the new structure will provide more horizontal and vertical articulation, provide bay views with the second level public viewing deck, and creation of 15-foot wide Harborwalk/bayside lateral access all of which provides articulation that is consistent with the character of the waterfront.
- 8. The proposed project does not diminish, either directly or by cumulative impact of several similar projects, the use, enjoyment, or attractiveness of adjacent buildings and provides a visual and pedestrian transition to its immediate neighbor in that the existing and new construction is in keeping with the architectural style, massing, materials, scale, and use of its surroundings.

Planned Development Overlay Finding

A. The Planning Commission finds the project as conditioned with the provision of public benefits including 15 foot Harborwalk where 10 foot is otherwise required, second floor public viewing deck, publicly accessible dock, and creation of public plaza improvements and event space in the adjacent street end constitutes greater than normal benefits and warrants modification of standards to allow a reduction in the second floor front setback, a small encroachment into the required diagonal view corridor at the southwest building corner, allow projecting pub signs as shown on project plans on the east and north elevation to be located less than 30 feet apart, less than 15 feet from edge of façade, and less than the minimum 4 square feet in size if desired by the applicant, and also to allow building height up to 25 feet where otherwise 17 feet would be the standard building height.

Architectural Consideration

A. As required by Ordinance Section 17.48.200 the Planning Commission finds that the architectural treatment and general appearance of all proposed structures and open areas are in keeping with the character of the surrounding areas, are compatible with any design themes adopted by the city, and are not detrimental to the orderly and harmonious development; of the city or to the desirability of investment of occupation in the area.

Design Review Finding

- A. Pursuant to 2022 Zoning Code Chapter 17.38, the Planning Commission finds that the overall design of the project including its form, scale, massing, site plan, exterior design, and landscaping will implement the General Plan Vision for Community Character Areas for the particular area in which it is located as well as complement the natural and built features of surrounding properties and incorporate sustainable development features.
- B. The project design is appropriate to the function of the project and will provide an attractive and comfortable environment for occupants, visitors, and the general community.

- certified Local Coastal Program Land Use Plan (LCP) in effect at the time of the extension request.
- C. <u>Changes</u>: Minor changes to the project description and/or conditions of approval shall be subject to review and approval by the Community Development Director. Any changes to this approved permit determined, by the Director, not to be minor shall require the filing of an application for a permit amendment subject to Planning Commission review.
- D. <u>Compliance with the Law</u>: (a) All requirements of any law, ordinance or regulation of the State of California, the City, and any other governmental entity shall be complied with in the exercise of this approval, (b) This project shall meet all applicable requirements under the MBMC, and shall be consistent with all programs and policies contained in the LCP and General Plan for the City.
- E. Hold Harmless: The applicant, as a condition of approval, hereby agrees to defend, indemnify, and hold harmless the City, its agents, officers, and employees, from any claim, action, or proceeding against the City as a result of the action or inaction by the City, or from any claim to attack, set aside, void, or annul this approval by the City of the applicant's project; or applicants failure to comply with conditions of approval. Applicant understands and acknowledges the City is under no obligation to defend any legal actions challenging the City's actions with respect to the project. This condition and agreement shall be binding on all successors and assigns.
- F. Compliance with Conditions: The applicant's establishment of the use or development of the subject property constitutes acknowledgement and acceptance of all Conditions of Approval. Compliance with and execution of all conditions listed hereon shall be required prior to obtaining final building inspection clearance. Deviation from this requirement shall be permitted only by written consent of the Director or as authorized by the Planning Commission. Failure to comply with any of these conditions shall render this entitlement, at the discretion of the Director, null and void. Continuation of the use without a valid entitlement will constitute a violation of the MBMC and is a misdemeanor.
- G. <u>Compliance with Morro Bay Standards</u>: This project shall meet all applicable requirements under the MBMC, and shall be consistent with all programs and policies contained in the LCP and General Plan of the City.
- H. <u>Conditions of Approval:</u> The Findings and Conditions of Approval shall be included as a full-size sheet in the Building Plans.

BUILDING CONDITIONS:

A. PRIOR TO ISSUANCE OF A BUILDING PERMIT:

- Building permit plans shall be submitted by a California licensed architect or engineer when required by the Business & Professions Code, except when otherwise approved by the Chief Building Official.
- 2. The owner shall designate on the building permit application a registered design professional who shall act as the Registered Design Professional in Responsible Charge. The Registered Design Professional in Responsible Charge shall be responsible for reviewing and coordinating submittal documents prepared by others including phased and staggered submittal items, for compatibility with design of the building.

- C. Project details, materials, signage and landscaping, are internally consistent, fully integrated with one another, and used in a manner that is visually consistent with the proposed architectural design.
- D. The design of streetscapes, including street trees, lighting, and pedestrian furniture, is consistent with the intended character of the area.
- E. Hardscape areas are designed and developed to buffer surrounding land uses; compliment pedestrian-oriented development; enhance the environmental quality of the site, including minimizing stormwater run-off and the heat-island effect; and achieve a safe, efficient, and harmonious development.
- F. Lighting and lighting fixtures are designed to complement buildings, be of appropriate scale, provide adequate light over walkways and parking areas to create a sense of pedestrian safety, avoid creating glare, and conform to dark sky principles.
- G. Landscaping is designed to be compatible with and enhance the vision for the Community Character Area in which the development is located as well as the architectural character and features of the buildings on site.

Downtown Waterfront Strategic Plan Finding

A. The Planning Commission finds that the project as proposed is consistent with the Waterfront Specific Design Guidelines in the 2018 Downtown Waterfront Strategic Plan as evaluated in the staff report. The project redesigns the lease site with the demolition and reconstruction of the existing two story building and improves the view corridor and improves overall public views through to the Bay. The project proposes design materials consistent with the fishing village character of the community and consistent with the materials of the adjacent lease site. The project proposes diagonal view corridors, and provides 15 feet of Harborwalk bayside lateral access where none currently exists. The project proposes a nautical design theme through the proposed commercial signage. The project as conditioned includes enhanced amenities such as a new public plaza, benches and informational signs, and the project also proposed appropriate lighting to encourage safety and comfort, but with downcast, shielded lighting fixtures.

Section 2. Action. The Planning Commission does hereby approve Conditional Use Permit #CUP22-09 subject to the following conditions:

STANDARD CONDITIONS

- A. This permit is granted for the land described in the staff report dated December 11, 2023, for the project at 801 Embarcadero depicted on plans dated November 1, 2023, on file with the Community Development Department, as modified by these conditions of approval, and more specifically described as follows: Site development, including all buildings and other features, shall be located and designed substantially as shown on Planning Commission approved plans submitted for CUP22-09, unless otherwise specified herein.
- B. Inaugurate Within Two Years: Unless the construction or operation of the structure, facility, or use is commenced not later than two (2) years after the effective date of this Resolution and is diligently pursued, thereafter, this approval will automatically become null and void; provided, however, that upon the written request of the applicant, prior to the expiration of this approval, the applicant may request up to two extensions for not more than one (1) additional year each. Any extension may be granted by the City's Community Development Manager (the "Director"), upon finding the project complies with all applicable provisions of the Morro Bay Municipal Code (the "MBMC"), General Plan and

- 3. The owner shall comply with the City's Structural Observation Program. The owner shall employ the engineer or architect responsible for the structural design, or another engineer or architect designated by the engineer of record or architect responsible for the structural design, to perform structural observation as defined in Section 220. Observed deficiencies shall be reported in writing to the owner's representative, special inspector, contractor and the building official. The structural observer shall submit to the building official a written statement that the site visits have been made and identify any reported deficiencies that, to the best of the structural observer's knowledge, have not been resolved.
- 4. The owner shall comply with the City's Special Inspection Program. Special inspections will be required by Section 1704 of the California Building Code. All Special Inspectors shall first be approved by the Building Official to work in the jurisdiction. All field reports shall be provided to the City Building Inspector when requested at specified increments in order for the construction to proceed. All final reports from Special Inspectors shall be provided to the Building Official when they are complete and prior to final inspection.
- 5. Mitigation measures for natural occurring asbestos require approval from San Luis Obispo County Air Pollution Control District.
- A soils investigation performed by a qualified professional shall be required for this project.
 All cut and fill slopes shall be provided with subsurface drainage as necessary for stability;
 details shall be provided. Alternative, submit a completed City of Morro Bay soils report
 waiver request.
- 7. BUILDING PERMIT APPLICATION. To apply for building permits submit three (3) sets of construction plans to the Building Division.
- 8. The Title sheet of the plans shall include:
 - a. Occupancy Classification(s)
 - b. Construction Type
 - c. Maximum height of the building allowed and proposed
 - d. Floor area of the building(s)
 - e. Fire sprinklers proposed or existing
 - f. Minimum building setback allowed and proposed

All construction will conform to the 2022 California Building Code (CBC), 2022 California Residential Code (CRC), 2022 California Fire Code (IFC), 2022 California Mechanical Code (CMC), 2022 California Plumbing Code (CPC), 2022 California Electrical Code (CEC), 2022 California Energy Code, 2022 California Green Building Code (CGBC), Title 14 and 17 of the Morro Bay Municipal Code.

(Code adoption dates are subject to change. The code adoption year is established by application date of plans submitted to the Building Division for plan review.)

B. CONDITIONS TO BE MET DURING CONSTRUCTION:

BUILDING DIVISION:

- 1. SITE MAINTENANCE. During construction, the site shall be maintained so as to not infringe on neighboring property, such as debris and dust.
- 2. ARCHAEOLOGICAL MATERIALS. In the event unforeseen archaeological resources are unearthed during any construction activities, all grading and or excavation shall cease in

the immediate area and the find left untouched. The Building Official shall be notified so that the extent and location of discovered materials may be recorded by a qualified archaeologist, Native American, or paleontologist, whichever is appropriate. The qualified professional shall evaluate the find and make reservations related to the preservation or disposition of artifacts in accordance with applicable laws and ordinances. If discovered archaeological resources are found to include human remains, or in any other case when human remains are discovered during construction, the Building Official shall notify to county coroner. If human remains are found to be of ancient age and of archaeological and spiritual significance, the Building Official shall notify the Native American Heritage Commission. The developer shall be liable for costs associated with the professional investigation.

- 3. FOUNDATION SETBACK VERIFICATION: Prior to the placement of concrete and upon completed form installation, a licensed surveyor is required to measure and record the distance from the proposed foundation walls to the established lot lines. The contractor shall submit these findings in letter format to the building inspector upon the request for a foundation inspection. Letter shall specify the findings of front, sides and rear yard setbacks as defined in Title 17 of the MBMC. The Building Official shall have discretion on a case-by-case basis for some lot types.
- 4. BUILDING HEIGHT VERIFICATION: Prior to roof sheathing or shear wall inspection, a licensed surveyor is required to measure and record the height of the structure. The contractor shall submit this finding in letter format to the building inspector upon the request for roof sheathing/shear wall inspection. Letter shall specify the recorded height of structure as defined in Title 17 of the MBMC. The Building Official shall have discretion on a case-by-case basis for some site-specific projects.
- EXISTING BUILDINGS: Where windows are required to provide emergency escape and rescue openings, replacement windows shall comply with the maximum sill height requirements of section R310.2.2 and the minimum opening area requirements of section R310.2.1 of the 2022 California Residential Code.

C. CONDITIONS TO BE MET PRIOR TO FINAL INSPECTION AND ISSUANCE OF CERTIFICATE OF OCCUPANCY:

BUILDING DIVISION:

- Prior to Building Division final approval all required inspections from the other various divisions must have been completed and verified by a city inspector. All required final inspection approvals must be obtained from the various departments and documented on the permit card.
- 2. Prior to building division final approval and request for final inspection, all required inspections from the other various divisions and departments must be completed and verified by a city inspector. All required final inspection approvals must be obtained from the various departments and documented on the permit card. This permit card shall then be turned into the building division for scheduling of the final building inspection.
- 3. Any as-built drawings that were required by the building inspector or plans examiner must be submitted for approval prior to the request for final inspection.

- 4. If structural observations were required, the final structural observation report shall be submitted to the building division prior to issuance of the certificate of occupancy or final inspection approval.
- 5. If special inspections were required, the final special inspection report shall be submitted to the building division prior to the issuance of the certificate of occupancy or final inspection approval.
- 6. Final soils summary report from the geotechnical representative indicating compliance with the required conditions set forth in the soils report.
- 7. Final T-24 energy reports (Certificates of Installation).

Fire Department Conditions:

- 1 Fire Protection Systems and Equipment. An approved automatic fire sprinkler system shall be provided throughout this project, pursuant to Morro Bay Municipal Code, Section 14.60.200.
- 2. Submit all plans and specification sheets for the required automatic fire sprinkler system to the Fire Department for review and approval prior to installation. Sprinkler plans shall be submitted prior to issuance of a Building Permit. The sprinkler system shall be in accordance with NFPA Standard 13. All Marine floating docks and gangway construction shall be in accordance with Morro Bay Municipal Code, Chapter 14.52 and 2007 California Fire Code (Section 905), a Class III Standpipe System is Required for the proposed Floating Dock.
- 3. Fire Alarms. Plans and specifications for the automatic fire sprinkler system and fire alarm system shall be submitted to the Fire Department for review and approval. (CFC 1001.3 and 1001.4) The fire sprinkler and alarm systems shall be supervised by a central station and constructed in accordance with NFPA 72.
- 4. Elevator Car to Accommodate Ambulance Stretcher. Where elevators are provided, at least one elevator shall be provided for fire department emergency access to all floors. The elevator car shall be of such a size and arrangement to accommodate an ambulance stretched 24-inches by 84-inches with not less than 5-inch radius corners, in the horizontal, open position and shall be identified by the international symbol for emergency medical services (star of life). The symbol shall not be less than 3-inches high and shall be placed inside on both sides of the hoist way door frame. (MBMC 14.08.090)

Public Works Conditions:

The following Public Works conditions shall be satisfied prior to Building Plan submittal:

- Lease Line Adjustment: A lease line adjustment is required to extend western lease line due to the proposed lease boundary line adjustments and requires payment of fees, a legal description and lease exhibit created by a licensed surveyor, a City Council Resolution approving the lease line adjustment, and a signed agreement recorded with the County. (MBMC 8.14.020)
- 2. Right of Way: A Special Encroachment Permit Agreement is required for structures and new design items within the city right way (where public parking current exists). (MBMC 8.14.020)

- Stormwater Management: The City has adopted Low Impact Development (LID) and Post Construction requirements. All proposed projects must complete the "Performance Requirement Determination Form" to determine if any requirements should be submitted. The requirements can be found in the Stormwater management guidance manual on the City's website: https://www.morrobayca.gov/DocumentCenter/View/11828/MB-Stormwater-Management-MAIN-Manual (MBMC 14.48.140)
- 4. Frontage Improvements: The installation of frontage improvements and upgrades to deteriorated frontage improvements are required. Show the installation of a City standard driveway approach per detail B-6, 8-foot minimum sidewalk per detail B-5, curb and gutter per B-1, and curb ramps per Caltrans detail A88A. Show and label 18" asphalt cutback at all portions of curb and gutter to be replaced. (MBMC 14.44.020)
- 5. Frontage Improvements: Spot elevations on Topographic Map suggest sidewalk cross-slope exceeds 2%. Show on plans replacement of all nonconforming sidewalks with ADA compliant sidewalks per Caltrans DIB 82-06 4.3.5(1).
- 6. Sewer Lateral: Indicate and label if private sewer lateral pipe will be replaced or to remain in place. If the existing sewer lateral is proposed to remain in place, then perform a video inspection of the lateral (from the clean-out at structure to the connection at the sewer mainline pipe) and submit to Public Works via flash drive, prior to building permit plan approval. Requirements for the sewer video inspection can be located on the City's website at the following location: https://www.morro-bay.ca.us/DocumentCenter/View/13500/Private-Sewer-Line-Video-Requirements. Lateral shall be upgraded, repaired or replaced as required to prohibit inflow/infiltration. All repairs or replacements identified from sewer video, shall be noted on approved set of plans, prior to plan approval. (MBMC 14.07.030)
- 7. Sewer Backwater Valve: Indicate and label sewer backwater valve on plan. A backwater valve, extended to and accessible from grade for maintenance, shall be installed on every Building sewer. Exception: Installation of backwater valve shall not be required when, to the satisfaction of Building Official, it is determined that the intent and purpose of this section is otherwise met. (MBMC 14.07.010.C).
- 8. Erosion and Sediment Control Plan: For small projects less than one acre and less than 15% slope, provide a standard erosion and sediment control plan. Show on plans the control measures to provide protection against erosion of adjacent property and prevent sediment or debris from entering the City right of way, adjacent properties, any harbor, waterway, or ecologically sensitive area. Guidelines for the control plan may be found on the City's website at the following location: https://www.morrobayca.gov/documentcenter/view/462
- Water Meter: Indicate on plans location and sizes of both water meter and water lateral. Coordinate sizes with Fire Sprinkler plans as necessary. (MBMC 13.04.010 & 14.04.010.C)
- 10. Water Backflow Prevention Device: Verify and label all new or existing water backflow preventers. Water backflow preventer devices are required for fire water systems, irrigation systems (on a dedicated water meter), systems which may change in character of use (commercial rentals, etc.), gray water systems, or any plumbing system which has cross-connections or the ability to allow water of deteriorated sanitary quality to enter the public water supply. Add note to plan that device is required to be an approved domestic water backflow prevention device. (MBMC 13.08.040)

- 11. Grading and Drainage: Indicate on plans the existing and updated contours, drainage patterns, spot elevations, finish floor elevation and all existing and proposed drainage pipes and structures. Clarify how runoff around structure will be directed to City right-ofway. (CBC 107.2.1)
- 12. Utilities: Show all existing and proposed locations of the sewer lateral, water service, and water and sewer mains on the building plans. Include sizes where appropriate. Note the location of all overhead utilities and construction underground service entrances per the CBC.
- 13. Debris Barrier: A Floating Debris Barrier shall be installed around the waterside perimeter of the construction site and maintained throughout the duration of the project. Note the beginning and end termini of the Floating Debris Barrier on Construction Plans. Silt screens and/ or straw waddles may be needed to prevent demolition/repair debris and sediments from entering the bay in the area of the piling repairs. The location of screens and waddles in this area should also be noted on the plans.
- 14. Flood Zone Requirements: A Flood Hazard Development Permit is required. The City's Flood Hazard Prevention Ordinance describes the requirements to obtain this permit. Pertinent requirements include, but are not limited to:
 - a) Per Section 14.72.050 A.3.a., new or substantial improvement construction, shall have the lowest floor (including basement) elevated two feet above the base flood elevation. Elevation data shall be based on NAVD 1988.
 - b) Submit a FEMA Elevation Certificate which will indicate the base flood elevation to be used with the proposed construction drawings. (Prior to Final Sign-off, submit an Elevation Certificate to indicate the finish elevations of the completed building.)
 - c) Verify that all mechanical and electrical machinery and controls (heating, A/C, etc.) is above BFE or flood proofed.

Add the following Notes to the Plans:

- 1. Any damage, as a result of construction operations for this project, to City facilities, i.e. curb/berm, street, sewer line, water line, or any public improvements shall be repaired at no cost to the City of Morro Bay.
- 2. No work shall occur within (or use of) the City's Right of Way without an encroachment permit. Encroachment permit application and requirements are available on the City's website at the following location: https://www.morro-bay.ca.us/197/Public-Works.
- A standard encroachment permit shall be required for the proposed driveway; the driveway shall comply with B-9 (Driveway Ramps: Size & Location).
- A sewer encroachment permit shall be required for any repairs or installation of a sewer lateral within the City right-of-way or within a utility easement.
- If a construction dumpster is used, the dumpster location shall be on private property, unless allowed by a temporary encroachment permit within the City right-of-way.

Planning Conditions:

- 1. A Coastal Development Permit shall be submitted to the Community Development Department prior to issuance of a building permit.
- Inspection: The applicant shall comply with all City conditions of approval and conditions imposed by the California Coastal Commission and obtain final inspection clearance from the Planning Division at the necessary time in order to ensure all conditions have been met.

- 3. <u>Bayside Lateral Public Accessway (Harborwalk)</u>. The bayside lateral access, also known as the Harborwalk, shall maintain a minimum 15-foot wide coastal access with open unobstructed access at all times with no tables or dining encroachments in order to maximize public access. Any uses that obstruct the lateral access such as private uses or barriers including furniture, planters, ropes, or restaurant seating within the 15 foot lateral access shall be prohibited.
- 4. Floating dock. The floating dock shall be publicly available for general public pedestrian access and either short-term or long-term use by recreational or commercial boats. Signs discouraging the public from walking on the docks during daylight hours are prohibited. The dock shall be open to the general public during at least daylight hours (i.e. one hour before sunrise to one hour after sunset).
- 5. Dock material as shown on Project Plans dated November 1, 2023 shall be revised with the building plan submittal to be composite decking material in lieu of fiberglass decking in order to have consistent materials pursuant to the DWSP design guidelines unless otherwise required by the preconstruction eelgrass survey and the California Eelgrass Mitigation Policy (CEMP).
- 6. The second floor public view deck as part of the public benefit shall be made open and available to the public during daylight hours.
- 7. Historical interpretive sign copy shall be reviewed and approved by the Community Development Director prior to issuance of the building permit.
- 8. Twenty five percent of hotel rooms shall be set at rates equal to the City's area low-cost threshold pursuant to LUP Policy LU-6.5 or as otherwise approved consistent with the coastal development permit. The low cost threshold would be established based on the City's Lower Cost Visitor Serving Accommodations Technical Memorandum, or Smith Travel Research data or not to exceed 75 percent of the prior year's statewide average daily rate.
- 9. The diagonal view corridors at southwest and southeast building corners shall be maintained with no furniture item or table umbrellas to exceed 30 inches in height per the Waterfront Master Plan. No podium, hostess stand or station shall be allowed within the required view corridor.
- 10. <u>Eelgrass</u> Applicant shall be subject to the California Eelgrass Mitigation Policy (CEMP) which requires that a pre-construction survey shall be completed within 30-60 days prior to issuance of a building permit. Post-construction survey shall be completed within 30 days of construction completion or as otherwise determined by the National Marine Fisheries Service (NMFS) in order to determine amount of impact if any and CEMP-required annual reporting and mitigations. Any eelgrass habitat shall be documented and reported to the Community Development Director. If the report identifies a reduction in eelgrass coverage then a plan shall be prepared to identify the appropriate mitigations necessary and in line with the specifications for mitigation of eelgrass habitat as provided for in the California Eelgrass Mitigation Policy, dated October 2014 or successor guiding document.
- 11. A Marine Wildlife Contingency Plan shall be developed and approved by the City of Morro Bay prior to the initiation of pile driving activities. This plan shall describe specific methods that will be used to reduce pile-driving noise. Power to the pile driver shall be ramped up to allow marine wildlife to detect a lower sound level and depart the area before full-power noise levels are produced. The plan shall identify a USFWS-approved biologist to monitor all construction within the water-lease area who shall be retained by the applicant. The

plan shall describe on-site marine wildlife monitoring and reporting requirements as well as identify specific conditions when the biological monitor shall be allowed to stop work, such as observance of a marine mammal within 100 feet of the project area. The biologist shall be responsible to monitor for compliance with all environmental mitigation measures, and regulatory permit conditions (as applicable). The approved biological monitor shall be present onsite during construction and shall have the authority to stop construction if any individuals of southern sea otter are seen within 100 feet of the project area. Construction will be allowed to resume after sighted otters have left the 100-foot radius of the project area. The species shall not be disturbed or forced from the project site by equipment, noise, or other disruptive activity. The monitor will have discretionary authority to temporarily halt the project if it is determined that the otter, or other marine mammal, could be affected by the project, even if the animal is beyond the 100-foot boundary. All construction crew employees shall be informed on the requirements of this condition.

- 12. A project-specific Oil Spill Response and Recovery Plan that includes specifics on reporting and response procedures, available on-site equipment and contracted services, and responsibilities shall be completed and approved prior to the initiation of construction activities. Specifically, the project shall include the following Best Management Practices (BMPs) and shall be included on building plans submitted for approval:
 - a. No refueling of equipment without adequate containment and spill response equipment. The barge shall have only double contained fuel storage below decks, with the spill containment and clean up kits on-site and easily accessible. Spill containment and clean up kits shall include the following:
 - b. 150 feet Absorbent Boom 200 square feet Absorbent Tarp (for use during pile driving operations)
 - c. Barrel Absorbent Pads
 - d. Container Absorbent Granules
 - e. Rainwater runoff pollution from equipment stored on deck shall be prevented through ongoing equipment maintenance and appropriate double containment.
 - f. The work area shall be contained within a boom to prevent debris from falling into the water.
 - g. All equipment fueling shall take place on the barge, with containment in-place. No refueling between vessels shall occur.
 - h. An Absorption Tarp shall be placed underneath any portable equipment while in use.
 - i. No equipment shall be permitted to enter the water with any petroleum products.
 - j. All equipment used during pile driving operations shall be in good condition without fuel or oil leakage.
 - k. Should any equipment begin to leak, that equipment shall be removed immediately from the barge and repaired or replaced.
 - All vessels shall have portable, regularly serviced sanitation equipment. No overboard discharge is permitted.
- 13. Prior to issuance of a building permit, a pile driving plan and hydroacoustical noise mitigation plan shall be submitted to the Community Development Director to ensure that underwater noise generated by pile driving activities is minimized to the maximum extent feasible and does not exceed: (1) an accumulated 187 dB SEL as measured 5 meters from the source; and (2) peak dB above 208 dB as measured 10 meters from the source as determined by the Fisheries Hydroacoustic Working Group. In the instance anything other than a vibratory hammer is to be used for pile driving activities, the plan shall provide for a hydro-acoustical monitor to ensure that underwater noise generated by pile driving activities does not exceed such limits. The plan shall identify the type of method used to install pilings. Vibratory hammers shall be used where feasible; if another method is used,

- a bubble curtain shall be employed to contain both noise and sediment. The plan shall also provide for additional acoustical BMPs to be applied if monitoring shows underwater noise above such limits (including, but not limited to, alternative pile driving methods (press-in pile placement, drilling, dewatered isolation casings, etc.) and additional noise dampening measures (sound shielding and other noise attenuation devices).
- 14. Netting or fencing around and underneath the project site shall be installed to catch and remove debris released during and after construction.
- 15. To reduce potential turbidity-associated impacts, silt screens should be used when and where they will be effective. The relatively high tidal currents within Morro Bay could reduce the effectiveness of silt screens and should be considered prior to placing of these screens.
- 16. Exterior lighting fixtures shall include specifications on the building plans submittal for approval consistent with Zoning Code section 17.14.090 that ensure exterior lighting is cut-off, shielded, or downward fixtures and is between 2600 and 3500 Kelvin and has a CRI of 85 or greater.
- 17. A minimum of three trash cans with self-closing lid or other bird deterrent as approved by the Community Development Director shall be identified on plans to be included with the building permit submittal.
- 18. A 4-8 capacity public bike rack shall be installed on the site and placed so as not to impede public pedestrian flow. Location and brand of bike rack shall be included with the building permit submittal. Bike rack shall be consistent with other City facilities or as otherwise approved by the Community Development Director.
- 19. Two benches available for general public use shall be located in the general public plaza area.
- 20. Building plans submitted for approval shall meet all accessibility requirements to both adjacent lease site and public ways and match the grades without requirement for handrails providing a smooth transition between lease sites.

Planning Commission conditions 21 and 22 added on December 19, 2023:

- 21. Exterior stairs along the south elevation shall be adjusted so there is clear 10-foot wide vertical access with minimum 8 foot clearance height.
- 22. The alternate second floor plan which shows two hotels rooms facing the bay as presented at the December 19, 2023 Planning Commission meeting shall be incorporated into the revised plan set for City Council CUP review.
- 23. Signage shall be added to entrance of public view deck and at street level announcing public access. Form and design of signage shall be consistent with the approval public coastal access signs as approved by the California Coastal Commission. Final public access signs shall be included and shown on the building permit plans and shall denote all signage locations.

//

//

24. A railing not to exceed 42 inches in height shall enclose the outdoor dining tables located on the west side of the building to prevent tables from encroaching into the required 15 foot Harborwalk lateral access. Design of the railing shall be included on building permit plans and approved by the Community Development Director.

City Council conditions 25 and 26 added on January 23, 2024:

- 25. Plaza improvements shall be deferred until a relocation plan is prepared that addresses relocation of parking spaces; or unless relocation of parking spaces for street ends is identified and included with approval of the future Waterfront Master Plan update. Deferral of the plaza improvements shall be included in the lease for the subject property. Plaza improvements shall be installed within 24 months of an approved relocation plan for the relocated parking spaces. Upon written determination by the City Manager and the Community Development Director, that parking relocation is unlikely, including but not limited to, through anticipated untimely delay of the waterfront master plan update, Applicant will within 30 calendar days deposit into the City's general fund for use in Harbor area by City a sum equal to the total amount of plaza improvement cost as reasonably determined by the Community Development Director based upon industry standards. If within 14 months after the building permit is issued for Applicant's project, plaza improvements have not been determined by the City to move forward then Applicant has the option of depositing said sum to the City, rather than waiting for a determination on whether or not parking relocation will or will not occur.
- 26. Staff will investigate ability to place an ADA parking space along the frontage or within street end and/or a passenger drop off loading zone space with priority toward providing an ADA parking space.

PASSED AND ADOPTED by the City Council of the City of Morro Bay at a regular meeting thereof held on this 23rd day of January, 2024, on the following vote:

AYES: NOES: ABSEN ABSTA RECUS	None IT: None IN: None	drum, Barton, Edwards, Ford	
		CARL	A WIXOM, Mayor
ATTEST			
DANA SWANS	SON, City Clerk		